

SITE SKETCH NOTES:

- 1. BY GRAPHIC PLOTTING ONLY, THIS PROPERTY APPEARS TO BE LOCATED IN FLOOD ZONE X, AS PER F.E.M.A. F.I.R.M. NUMBER 45015C 0695 E, EFFECTIVE DATE: DECEMBER 7, 2018.
- 2. AREA WAS DETERMINED BY COORDINATE METHOD.
- 3. HORIZONTAL DATUM = NAD '83 VERTICAL DATUM = NAVD '88
- 4. BERKELEY COUNTY TMS NUMBERS, 259-00-00-125 & -170.
- 5. THE PUBLIC RECORDS REFERENCED ARE ONLY THOSE USED FOR THE ESTABLISHMENT OF THE BOUNDARY OF THIS PROPERTY. THEY ARE NOT AND DO NOT CONSTITUTE A TITLE SEARCH.
- 6. ANYTHING SHOWN OUTSIDE THE DEFINED BOUNDARY OF THIS PLAT IS FOR DESCRIPTIVE PURPOSES ONLY.
- 7. PROPERTY MAY BE SUBJECT TO EASEMENTS AND RESTRICTIONS NOT OBVIOUS OR APPARENT TO THE SURVEYOR.
- 8. THIS SITE AREA IS ZONED PD.
- 9. THERE ARE WETLANDS ON SUBJECT PROPERTY AS SHOWN
- 10. SUBJECT TO CHANGE PER ENGINEERING PLANS.

		U	UKVE TABLE		
CURVE	RADIUS	LENGTH	DEL TA	CHORD	CHORD BEARING
C1	12.50'	19.63'	90'00'00"	17.68'	S 80'32'29" E
C2	<i>87.00</i> ′	17.46'	11'29'51"	17.43'	S 29'47'33" E
<i>C3</i>	451.00°	<i>52.85</i> '	6'42'50"	<i>52.82</i> '	N 27'24'02" W
C4	12.50'	9.08'	41 36 26"	<i>8.88</i>	S 09*57'13" E

		- <i>-</i>
	LINE DAT	<u>A</u>
LINE	LENGTH	BEARING
L1	41.61'	S54*27'31"W
L2	20.00'	N35'32'29"W
L3	19.88'	N35*32'29"W
L4	6.78'	S54*27'31"W
L5	23.18'	N35'32'29"W
L6	217.56	N24°02'37"W
<i>L7</i>	147.57'	N30'45'27"W
L8	24.26'	N29°49'08"W
L9	11.12'	N29'49'08"W
L10	56.68'	N58°28'17"E
L11	6.02'	N16'14'28"W
L12	24.81'	N6717'33"E
L13	6.81'	N6717'33"E
L14	59.64	S30°09'51"E
L15	70.89'	N57°21'53"E
L16	128.08'	N57"15"13"E
L17	63.74'	S21'30'17"E
L18	100.00'	N68°29'43"E

GREENWAY AT BOWEN SITE SUMMARY

TOTAL BOUNDARY = 4.138 AC.


TOTAL NUMBER OF SINGLE FAMILY & TOWN

HOME LOTS = 36

TOTAL LOTS AREA = 1.060 AC.

AVERAGE LOT SIZE = 20'x65' = 1.300 S.F.

MULTI PURPOSE BUILDING = 1

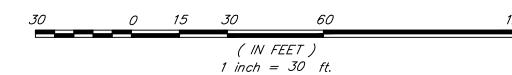

OSTER CREEK VILLAGE

POSTER ULLAGE


POSTER VILLAGE


PERMAHAN

NTY, SOUTH CAROLINA

CAROLINIS SIRIEMING, LLC ON THE SIRIEMING, L

urker Land Surveying, LLC 5910 Griffin Street
Hanahan, SC 29410
Phone: (843) 554-7777
Fax: (843) 554-7779

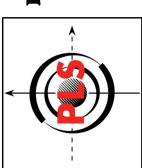

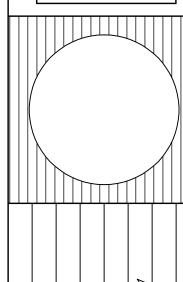

DRAWN: WMVCHECKED: WMVAPPROVED: ACGSCALE: 1" = 30'DATE: 1/8/2021PROJECT NO: 10046

CITY ADMINISTRATOR MIKE COCHRAN



CITY COUNCIL
JEFF C. CHANDLER, MAYOR PRO-TEM
MIKE DYSON
KEVIN HEDGPETH
JOEL E. HODGES
DAN OWENS
MICHAEL SALLY

Staff Report

To: The Hanahan Planning Commission

Cc: Larry Sturdivant, Building Official; Garri Steade, Prestwick

Development; Wes Bolin, PE, Site Design, Inc.

From: Jeff Hajek, Planner/Economic Development Director

Date: February 2, 2021

Re: Preliminary Land Development Plan Approval for The Park at Hanahan

Senior Living Development

Applicant/Owner: Prestwick Development

Location: Northside of Tanner Ford Boulevard, west of Hanahan Crossing (Super

BiLo) Shopping Center

Tax Map Number(s): 259-00-00-145

Approval Requested: Preliminary Development Plan Approval

Existing Zoning/Land Use: Multifamily Residential (RM)/undeveloped

General Application Overview and Background

The proposed site is located on the northern side of Tanner Ford Boulevard, adjacent to the Tanner Ford Boulevard and Tanner Hall Boulevard intersection. The existing site is currently undeveloped and consists of wooded uplands, with a small portion of wetlands in the northern area of the parcel. The subject property is flanked by an approximately one-hundred-foot-wide wetlands property to the west and north, the Hanahan Crossing Shopping Center (Lowes Foods) to the east and Tanner Ford Boulevard to the south.

The applicant is proposing to construct a four-story multifamily building, with 72 units, on a 3.15-acre parcel. Units range from 760 SF (48 units) to 970 SF (24 units). To allow for resident and guest parking, one parking lot, consisting of 108 stalls, will be provided in the northern area of the property behind the apartment building. The required amount of parking stalls (1.5 parking stalls for every apartment unit) has been met, in addition to the ADA parking stall requirement.

The majority of the parcel will be developed into housing and parking (56% lot coverage), with open space, which will be slightly under one (1) acre (22% of the development) and will be maintained by the owner.

CITY ADMINISTRATOR MIKE COCHRAN



CITY COUNCIL
JEFF C. CHANDLER, MAYOR PRO-TEM
MIKE DYSON
KEVIN HEDGPETH
JOEL E. HODGES
DAN OWENS
MICHAEL SALLY

Proposed access will be primarily off Tanner Ford Boulevard for the development and will be a "right in/right out" configuration. Secondary access will be through the Hanahan Crossing shopping center. The developer is proposing sidewalks throughout the development. Additionally, the owner is proposing a sidewalk from the subject property, along the primary access, to connect with the existing Tanner Trail, a pedestrian and bicycle pathway.

Utilities for Charleston Water System (CWS), Berkeley County Water and Sanitation Authority (BCWS) and Dominion Power are existing and little infrastructure enhancements, other than connections and extensions will be needed.

Consistency with RM Ordinance

Overall, the proposed multifamily use is compatible with the surrounding zoning districts, which are Single-Family Residential (RS) to the west of the site and General Commercial (CG) to the east of the site. The proposed development will provide a proper transition from RS to CG, concerning intensity of use and gradation of densities. Additionally, the intended use of the property, proposed solely for the City's senior population, will fit the character of the surrounding neighborhoods and commercial area.

Furthermore, as mentioned in the Background section, nearly a third of the property's western boundary consists of wetlands. This heavily wooded area will remain and act as a buffer between the proposed development and The Gardens at Tanner Plantation subdivision, providing a natural transition to the development. Technically, this wooded, wetland property (owned by the original seller) is zoned Commercial (CG), so the developer is not required to provide a landscaped buffer. The developer will also be providing generous buffers along the southern and eastern sides of the development. Again, these buffers are not required because they abut a commercial zone but will nonetheless enhance the property and its surroundings.

Lastly, the intended use, senior multifamily housing, provides a much-needed housing typology for the City. Currently, there are no senior apartment communities anywhere in Hanahan, and current residents are forced to look outside of the City to find this type of housing or figure out other arrangements. Additionally, the proposed development will be located adjacent to a grocery store, restaurants and the first segment of the Tanner Trail, all of which aid in providing a pedestrian-oriented community that allows its residents the ability to "age in place" in their city.

CITY ADMINISTRATORMIKE COCHRAN



CITY COUNCIL
JEFF C. CHANDLER, MAYOR PRO-TEM
MIKE DYSON
KEVIN HEDGPETH
JOEL E. HODGES
DAN OWENS
MICHAEL SALLY

General Conformance Analysis

The following report utilized the 2008 Hanahan Zoning Ordinance, specifically Section 4.5.6 (Multifamily Residential [RM]) to analyze the submitted preliminary land development plan for the Park at Hanahan development.

Per the Zoning Ordinance, staff finds the following general conformance standards for the proposed site:

- Lot size—Section 4.5.6 does not require a minimum lot size for proposed multifamily developments.
- 2. Lot Width— There is no minimum lot width.
- 3. **Density** 35 units per acre maximum. The proposed development meets this requirement currently at approximately 22.8 units per acre.
- 4. **Setbacks**—All proposed building sites meet the required setbacks as dictated by the ordinance. Below are the required:

Front: 15'Side: 20'Rear: 15'

5. **Impervious Surface Ratio**—65% maximum allowed. Developer is proposing 56% lot coverage.

Preliminary Plat Requested Corrections

Given that the submitted preliminary subdivision plat meets general zoning conformance, there are other pertinent and required elements needed to have a complete submittal. These documentation requirements may be found in the 2008 Zoning Ordinance, Section 3.2. The following will be needed for approval;

Required Contents of the Preliminary Plan (Section 3.2)

Proposed Land Development Information

- 1. Section 3.2(B)(4)(b): Proposed name for "New Right In/Right Out Driveway" will need to be pre-approved by Berkeley County E-911.
- 2. Detention pond will need to be shown on Sheet C200 (Site Plan). Pond is shown on C400 (Grading and Drainage Plan) and L100 (Landscape Plan).

CITY ADMINISTRATORMIKE COCHRAN



CITY COUNCIL
JEFF C. CHANDLER, MAYOR PRO-TEM
MIKE DYSON
KEVIN HEDGPETH
JOEL E. HODGES
DAN OWENS
MICHAEL SALLY

Other

Fire/EMS Public Safety

The Fire Chief (Joseph Bowers) is requesting an additional one (1) fire hydrant to the currently proposed two (2) hydrants. Said fire hydrant will need to placed in southwestern corner of the parcel, adjacent to the primary access and near the southwestern corner of the proposed apartment building.

Traffic Study

Per Section 3.3, a traffic study is required as part of a complete preliminary land development plan application or zoning permit for any land development projected to generate one hundred (100) or more peak-hour vehicle trips at any intersection at the perimeter of the development.

Currently, the developer is working with Berkeley County and utilizing supplementary TIA (Traffic Impact Analysis) data provided by the adjacent development, Parker's Kitchen to complete their traffic study.

Submittal to Respective Utilities

The applicant will need to ensure that the preliminary plan has been submitted to Charleston Water System (CWS), Berkeley County Water and Sanitation (BCWS) and Berkeley County Engineering for general review and review for stormwater management.

Copies of the eventual construction plans will also need to be submitted to Berkeley County Engineering. Comments received by said agencies may affect changes to the preliminary plan.

Recommendation

This plan constitutes a preliminary plat subdivision submittal. Approval of this plan does not imply approval of permits to begin construction. Approval of this application will enable the developer to seek permits for land disturbance and installation of necessary infrastructure to serve this phase of the project. Subsequent to approval to install infrastructure, the applicant must submit a final plat that depicts all easements provided for its maintenance, whether by a public

CITY ADMINISTRATORMIKE COCHRAN



CITY COUNCIL
JEFF C. CHANDLER, MAYOR PRO-TEM
MIKE DYSON
KEVIN HEDGPETH
JOEL E. HODGES
DAN OWENS
MICHAEL SALLY

agency or property owners association. Such plat must be approved and recorded prior to transfer of individual lots depicted on this plan.

Based upon staff's review, the City recommends that the Planning Commission *approve* the submitted preliminary land development plan for the "The Park at Hanahan" senior, multifamily development with conditions. Said conditions include:

- 1. Addressing all requested information in the "Preliminary Plat Requested Corrections" section of this staff report.
- 2. Addressing all "Other" requested information in this staff report, which includes: "Fire/EMS Public Safety" and "Traffic Study."
- 3. Receipt of recommendation/approval letters from CWS, BCWS and Berkeley County Engineering.

EROSION CONTROL NOTES

- SUBJECT PROPERTY:
 - TAX MAP NO. 2590000145 1000 TANNER FORD BLVD, HANAHAN, SC
 - BERKELEY COUNTY SOIL TYPE: DuA, DuB (Duplin), Be (Bethera) HYDROLOGIC SOIL GROUP C/D; BoB (Bonneau) HSG B
- SEDIMENT AND EROSION CONTROL DEVICES SHALL BE INSTALLED AND FUNCTIONING PRIOR TO BEGINNING ANY PROJECT EARTH
- TO SECURE THE PROJECT SITE, LOCATE LIMITS OF CONSTRUCTION, PROTECT AREAS THAT ARE TO REMAIN UNDISTURBED, AND PREVENT MIGRATION OF CONSTRUCTION DEBRIS. ORANGE CONSTRUCTION FENCING SHALL BE INSTALLED AROUND AREAS NOT REQUIRING SILT FENCING. ANY ACCUMULATION OF CONSTRUCTION DEBRIS ON PUBLIC ROADWAYS OR ADJACENT PROPERTIES

SHALL BE REMOVED WITHIN 24 HOURS. CARE SHALL BE TAKEN WHEN INSTALLING CONSTRUCTION FENCING TO NOT OBSCURE

- CONTRACTOR(S) TO MAINTAIN EROSION CONTROL MEASURES UNTIL GRASSING IS ESTABLISHED. OWNER WILL BE RESPONSIBLE FOR FROSION CONTROL MAINTENANCE THEREAFTER
- A CERTIFIED EROSION PREVENTION AND SEDIMENT CONTROL (CEPSCI) INSPECTOR SHALL BE MAINTAINED TO PROVIDE INSPECTION AND DOCUMENTATION OF EP&SC PRACTICES THROUGHOUT CONSTRUCTION IN ACCORDANCE WITH SCDHEC

ONCOMING TRAFFIC AT INTERSECTIONS, ADJACENT DRIVEWAYS AND THE PROJECT CONSTRUCTION ENTRANCE.

- SHALL NOTIFY THE INSPECTOR WITHIN 1 BUSINESS DAY IF A RAINFALL EVENT EQUAL TO OR GREATER THAN 0.5" HAS OCCURRED
- ALL SEDIMENT AND EROSION CONTROL DEVICES SHALL BE INSPECTED ONCE EVERY SEVEN (7) DAYS AND WITHIN 24 HOURS AFTER EACH RAINFALL EVENT THAT PRODUCES 1/2 INCH OR MORE OF PRECIPITATION. DAMAGED OR INEFFECTIVE DEVICES SHALL BE REPAIRED OR REPLACED AS NECESSARY. WRITTEN INSPECTION REPORTS SHALL BE KEPT ON SITE. IF POSSIBLE, SUPPORTING PHOTOGRAPHS SHALL ALSO BE RECORDED ALONG WITH THE INSPECTION REPORT. A WRITTEN MAINTENANCE RECORD OF ALL REPAIRS TO SEDIMENT/EROSION CONTROL DEVICES SHALL ALSO BE MAINTAINED AND KEPT ON SITE. REGULAR MAINTENANCE SHALL ALSO BE PERFORMED INCLUDING REMOVAL OF SILT FROM AROUND CATCH BASINS AND REPAIR CONSTRUCTION
- ANY MODIFICATIONS FROM THE APPROVED PLANS TO THE SEDIMENT/EROSION CONTROL FEATURES INSTALLED ON SITE SHALL BE RECORDED WITH INITIALS AND DATE ON THE STORMWATER POLLUTION PREVENTION PLAN (SWPPP) AND THE DESIGN ENGINEER SHALL BE NOTIFIED. THE DESIGN ENGINEER SHALL BE NOTIFIED IF ANY MAJOR CHANGES IN THE SWPPP ARE REQUIRED.
- ALL DISTURBED AREAS SHALL RECEIVE TOPSOIL & BE GRASSED IN ACCORDANCE WITH THE FOLLOWING SPECIFICATIONS:

NUISANCE ORDINANCE.

- A. LIME: 2 TONS PER ACRE B. FERTILIZER: 1000 LBS PER ACRE OF 10-10-10
- C. SEED: PER GRASSING SCHEDULE DETAIL
- **MULCH: 1.5 TONS PER ACRE WHEAT STRAW**


IF TEMPORARY VEGETATION IS REQUIRED TO ASSIST IN SILTATION CONTROL, FOLLOW THE GRASSING SCHEDULE DETAIL.

- 10. SOIL DISTURBANCE SHOULD BE LIMITED TO AREAS BEING ACTIVELY WORKED. STABILIZATION MEASURES SHALL BE INITIATED AS SOON AS PRACTICABLE IN PORTIONS OF THE SITE WHERE CONSTRUCTION ACTIVITIES HAVE TEMPORARILY OR PERMANENTLY CEASED, BUT IN NO CASE MORE THAN FOURTEEN (14) DAYS AFTER WORK HAS CEASED.
- SLOPES STEEPER THAN 3:1 AND/OR EXCEEDING EIGHT (8) VERTICAL FEET SHOULD BE STABILIZED WITH FLEX TERRA OR SYNTHETIC/VEGETATIVE MATS IN ADDITION TO HYDRO SEEDING. TEMPORARY SLOPE DRAINS SHALL BE INSTALLED AS NECESSARY DURING CONSTRUCTION WHERE SAID SLOPES EXCEED EIGHT (8) VERTICAL FEET
- 12. CAT TRACK OR SURFACE ROUGHENING IS REQUIRED FOR ALL SLOPES GREATER THAN 4:1 PRIOR TO SEEDING AND LYING OF SYNTHETIC OR VEGETATIVE MATS. CAT TRACKING OR SURFACE ROUGHENING SHALL PRODUCE A SURFACE WITH FURROWS RUNNING ACROSS THE SLOPE, PARALLEL WITH SLOPE CONTOURS, AND PERPENDICULAR TO SURFACE RUNOFF.
- 13. SILT FENCES SHALL BE CLEANED OR REPLACED WHEN SEDIMENT REACHES 1/3 HEIGHT OF THE FENCE OR WHEN THE SILT FENCE BECOMES INEFFECTIVE, WHICHEVER COMES FIRST.
- 14. PROVIDE SILT FENCE AND/OR OTHER CONTROL DEVICES. AS MAY BE REQUIRED. TO CONTROL SOIL EROSION DURING UTILITY CONSTRUCTION, ALL DISTURBED AREAS SHALL BE CLEANED, GRADED AND STABILIZED WITH GRASSING IMMEDIATELY AFTER THE UTILITY INSTALLATION. FILL, COVER, AND TEMPORARY SEEDING AT THE END OF EACH DAY ARE RECOMMENDED. IF WATER IS ENCOUNTERED WHILE TRENCHING. THE WATER SHOULD BE FILTERED TO REMOVE ANY SEDIMENTS BEFORE BEING PUMPED BACK
- 15. SILT FENCE SHALL BE INSTALLED ALONG LINES OF EQUAL ELEVATION. TIE BACKS SHALL BE INSTALLED EVERY 100 LINEAR FEET ALONG THE FENCE LINE.
- 17. ALL EROSION CONTROL DEVICES SHALL BE PROPERLY MAINTAINED DURING ALL PHASES OF CONSTRUCTION UNTIL COMPLETION OF ALL CONSTRUCTION ACTIVITIES AND ALL DISTURBED AREAS HAVE BEEN STABILIZED. ADDITIONAL CONTROL DEVICES MAY BE REQUIRED DURING CONSTRUCTION IN ORDER TO CONTROL EROSION AND/OR OFF SITE SEDIMENTATION. ALL TEMPORARY CONTROL DEVICES SHALL BE REMOVED ONCE CONSTRUCTION IS COMPLETE AND THE SITE IS STABILIZED.
- . DURING THE COURSE OF CONSTRUCTION ACTIVITIES EROSION AND SEDIMENT CONTROLS SHALL BE USED TO PREVENT SEDIMENT ACCUMULATION ON PUBLIC ROADWAYS (INCLUDING STREET GUTTERS), SEDIMENT LADEN RUNOFF FROM ENTERING INTO EXISTING STORM WATER SYSTEM INLETS OR DEPOSITING ON ADJACENT PROPERTIES, AND AIRBORNE DUST MIGRATION OFF-SITE. ANY ACCUMULATION OF SEDIMENT FROM THE PROJECT SITE ON PUBLIC ROADWAYS OR ADJACENT PROPERTIES SHALL BE REMOVED WITHIN 24 HOURS.
- 19. THE CONTRACTOR MUST TAKE NECESSARY ACTION TO MINIMIZE THE TRACKING OF MUD ONTO THE PAVED ROADWAY FROM CONSTRUCTION AREAS. THE CONTRACTOR SHALL DAILY REMOVE MUD/SOIL FROM PAVEMENT, AS MAY BE REQUIRED.
- 20. THE CONTRACTOR SHALL CONTROL DUST AS NECESSARY USING DUST CONTROL BMPs INCLUDING PROJECT PHASING, VEGETATIVE COVER, MULCH, SPRINKLING WATER, BARRIERS AND/OR COVERS.
- 21. TEMPORARY STOCKPILING OF USEABLE OR WASTE MATERIALS FOR MORE THAN SEVEN (7) DAYS SHALL HAVE APPROPRIATE EROSION AND SEDIMENT CONTROL MEASURES INSTALLED. THE CONTRACTOR SHALL PROVIDE STOCKPILE MANAGEMENT PER BMPs AS DESCRIBED IN THE SCDOT WATER QUALITY PROTECTION DURING CONSTRUCTION FIELD MANUAL (JANUARY 2004) SECTION 8.6. ACTIVE STOCKPILES SHALL BE COVERED, STABILIZED OR PROTECTED WITH TEMPORARY LINEAR SEDIMENT BARRIER PRIOR TO THE ONSET OF PRECIPITATION.
- 22. TEMPORARY STOCKPILES SHALL BE PLACED A MINIMUM OF 50 FEET AWAY FROM CONCENTRATED STORM WATER FLOWS, DRAINAGE COURSES, STORM WATER INLET STRUCTURES, ADJACENT PROPERTY, AND PUBLIC ROADWAYS. REPAIR AND/OR REPLACE PERIMETER CONTROLS AS NECESSARY. SEDIMENT SHALL BE REMOVED WHEN SEDIMENT ACCUMULATION REACHES 1/3 OF THE BARRIER HEIGHT.
- 23. THE CONTRACTOR IS RESPONSIBLE FOR THE DESIGN AND IMPLEMENTATION OF ANY SEDIMENT CONTROL DEVICES NEEDED OR REQUIRED AT BORROW OR HAUL AREAS. THE CONTRACTOR SHALL BE RESPONSIBLE FOR OBTAINING A GRADING AND/OR MINING PERMIT FOR OFFSITE BORROW PITS AND/OR STOCKPILE AREAS.
- 24. SOLID WASTE DISPOSAL SHALL BE IN COMPLIANCE WITH SCDHEC SOLID WASTE REGULATIONS AND SPARTANBURG COUNTY
- 25. THE CONTRACTOR SHALL ESTABLISH AN APPROPRIATE AREA ON SITE FOR TOPSOIL STORAGE. STOCKPILE SHALL BE STABILIZED AND SILT FENCE SHALL BE INSTALLED TO PREVENT SEDIMENTATION. CONTRACTOR SHALL COORDINATE WITH LANDSCAPING CONTRACTOR AND OWNER FOR DISTRIBUTION OF TOPSOIL ON SITE.
- 26. ALL EXISTING OR NEW STORM WATER STRUCTURES SHALL BE CLEANED OF ANY ACCUMULATED CONSTRUCTION DEBRIS OR SEDIMENTS FROM THIS PROJECT SITE. DISPOSAL OF ALL RECOVERED SEDIMENTS AND CONSTRUCTION DEBRIS SHALL BE IN ACCORDANCE WITH ALL APPLICABLE CITY, STATE AND FEDERAL REGULATIONS.
- 27. THE CONTRACTOR AND OWNER SHALL ALLOW BERKELEY COUNTY OR OTHER IMPLEMENTING AGENCY TO CONDUCT ONSITE
- 28. A MINIMUM 10' WIDE BUFFER SHALL BE MAINTAINED ALONG THE EDGES OF ALL WETLANDS DURING DEMOLITION AND CONSTRUCTION ACTIVITY.
- 29. TEMPORARY TOILETS, IF USED DURING CONSTRUCTION, SHALL NOT BE PLACED WITHIN 50' OF AN EXISTING OR PROPOSED
- STORMDRAIN INLET OR OUTLET.
- 30. TEMPORARY CONCRETE TRUCK WASH OUT AREAS SHALL NOT BE PLACED WITHIN 50' OF AN EXISTING OR PROPOSED STORMDRAIN
- 31. ANY GROUNDWATER ENCOUNTERED WHILE TRENCHING MUST BE FILTERED PRIOR TO DISCHARGE.

The contractor shall coordinate with the engineer of record for a digital staking plan to establish complete horizontal and vertical control. The contractor is responsible for survey stakeout of all improvements. Discrepancies between the plans, construction stakes, and field conditions shall be reported to the engineer of record immediately for resolution prior to installation of proposed improvements.

THE PARK AT HANAHAN

CITY OF HANAHAN BERKELEY COUNTY, SOUTH CAROLINA

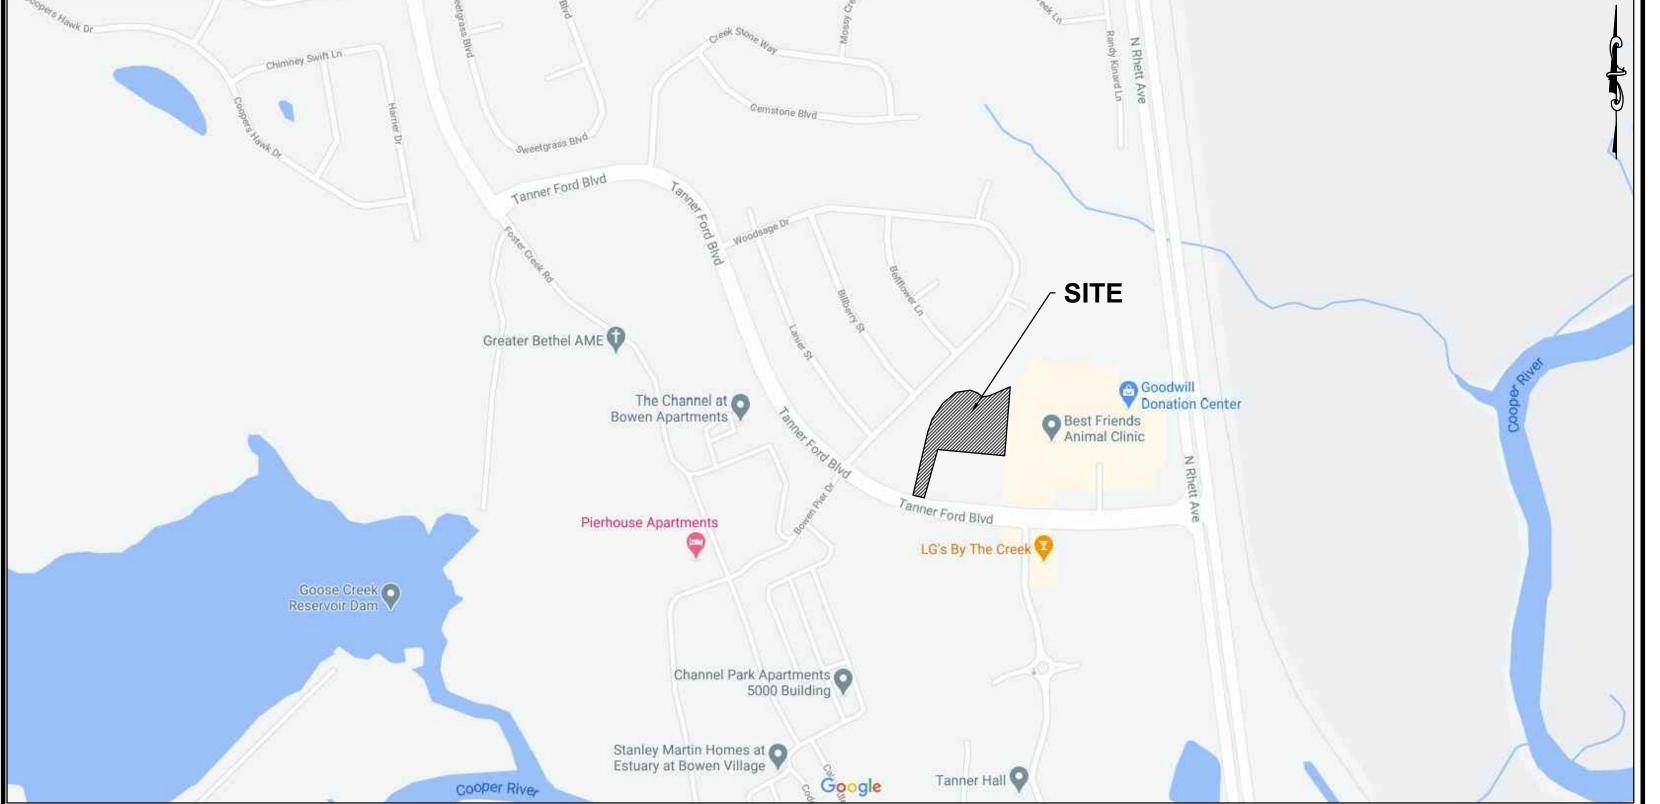

STANDARD SCDHEC NOTES

SEDIMENT BEFORE BEING PUMPED BACK INTO ANY WATERS OF THE STATE.

- IF NECESSARY, SLOPES, WHICH EXCEED EIGHT (8) VERTICAL FEET SHOULD BE STABILIZED WITH SYNTHETIC OR VEGETATIVE MATS, IN ADDITION TO HYDROSEEDING, IT MAY BE NECESSARY TO INSTALL TEMPORARY SLOPE DRAINS DURING CONSTRUCTION, TEMPORARY BERMS MAY BE NEEDED UNTIL THE
- STABILIZATION MEASURES SHALL BE INITIATED AS SOON AS PRACTICABLE IN PORTIONS OF THE SITE WHERE CONSTRUCTION ACTIVITIES HAVE TEMPORARILY OR PERMANENTLY CEASED, BUT IN NO CASE MORE THAN FOURTEEN (14) DAYS AFTER WORK HAS CEASED, EXCEPT AS STATED BELOW. WHERE STABILIZATION BY THE 14TH DAY IS PRECLUDED BY SNOW COVER OR FROZEN GROUND CONDITIONS STABILIZATION MEASURES MUST BE INITIATE. AS SOON AS PRACTICABLE.
- WHERE CONSTRUCTION ACTIVITY ON A PORTION OF THE SITE IS TEMPORARILY CEASED, AND EARTH-DISTURBING ACTIVITIES WILL BE RESUMED WITHIN 14 DAYS, TEMPORARY STABILIZATION MEASURES DO NOT HAVE TO BE INITIATED ON THAT PORTION OF THE SITE. ALL SEDIMENT AND EROSION CONTROL DEVICES SHALL BE INSPECTED ONCE EVERY CALENDAR WEEK. IF PERIODIC INSPECTION OR OTHER INFORMATION INDICATES THAT A BMP HAS BEEN INAPPROPRIATELY OR INCORRECTLY INSTALLED, THE PERMITTEE MUST ADDRESS THE NECESSARY REPLACEMENT OR
- MODIFICATION REQUIRED TO CORRECT THE BMP WITHIN 48 HOURS OF IDENTIFICATION. PROVIDE SILT FENCE AND/OR OTHER CONTROL DEVICES, AS MAY BE REQUIRED, TO CONTROL SOIL EROSION DURING UTILITY CONSTRUCTION. ALL DISTURBED AREAS SHALL BE CLEANED, GRADED, AND STABILIZED WITH GRASSING IMMEDIATELY AFTER THE UTILITY INSTALLATION. FILL, COVER, AND TEMPORARY SEEDING AT THE END OF EACH DAY ARE RECOMMENDED. IF WATER IS ENCOUNTERED WHILE TRENCHING, THE WATER SHOULD BE FILTERED TO REMOVE
- ALL EROSION CONTROL DEVICES SHALL BE PROPERLY MAINTAINED DURING ALL PHASES OF CONSTRUCTION UNTIL THE COMPLETION OF ALL CONSTRUCTION ACTIVITIES AND ALL DISTURBED AREAS HAVE BEEN STABILIZED. ADDITIONAL CONTROL DEVICES MAY BE REQUIRED DURING CONSTRUCTION IN ORDER TO CONTROL EROSION AND/OR OFFSITE SEDIMENTATION. ALL TEMPORARY CONTROL DEVICES SHALL BE REMOVED ONCE CONSTRUCTION IS COMPLETE AND THE SITE IS STABILIZED
- THE CONTRACTOR MUST TAKE NECESSARY ACTION TO MINIMIZE THE TRACKING OF MUD ONTO PAVED ROADWAY(S) FROM CONSTRUCTION AREAS AND THE GENERATION OF DUST. THE CONTRACTOR SHALL DAILY REMOVE MUD/SOIL FROM PAVEMENT, AS MAY BE REQUIRED. RESIDENTIAL SUBDIVISIONS REQUIRE EROSION CONTROL FEATURES FOR INFRASTRUCTURE AS WELL AS FOR INDIVIDUAL LOT CONSTRUCTION. INDIVIDUAL PROPERTY OWNERS SHALL FOLLOW THESE PLANS DURING CONSTRUCTION OR OBTAIN APPROVAL OF AN INDIVIDUAL PLAN IN ACCORDANCE WITH S.C REG.
- 72-300 ET SEQ. AND SCR100000 TEMPORARY DIVERSION BERMS AND/OR DITCHES WILL BE PROVIDED AS NEEDED DURING CONSTRUCTION TO PROTECT WORK AREAS FROM UPSLOPE RUNOFF AND/OR TO DIVERT SEDIMENT-LADEN WATER TO APPROPRIATE TRAPS OR STABLE OUTLETS.
- ALL WATERS OF THE STATE (WOS), INCLUDING WETLANDS, ARE TO BE FLAGGED OR OTHERWISE CLEARLY MARKED IN THE FIELD, A DOUBLE ROW OF SILT FENCE IS TO BE INSTALLED IN ALL AREAS WHERE A 50-FOOT BUFFER CAN'T BE MAINTAINED BETWEEN THE DISTURBED AREA AND ALL WOS. A 10-FOOT BUFFER SHOULD BE MAINTAINED BETWEEN THE LAST ROW OF SILT FENCE AND ALL WOS. LITTER, CONSTRUCTION DEBRIS, OILS, FUELS, AND BUILDING PRODUCTS WITH SIGNIFICANT POTENTIAL FOR IMPACT (SUCH AS STOCKPILES OF FRESHLY

TREATED LUMBER) AND CONSTRUCTION CHEMICALS THAT COULD BE EXPOSED TO STORMWATER MUST BE PREVENTED FROM BECOMING A POLLUTANT SOURCE

- IN STORM WATER DISCHARGES A COPY OF THE SWPPP, INSPECTIONS RECORDS, AND RAINFALL DATA MUST BE RETAINED AT THE CONSTRUCTION SITE OR A NEARBY LOCATION EASILY ACCESSIBLE DURING NORMAL BUSINESS HOURS, FROM THE DATE OF COMMENCEMENT OF CONSTRUCTION ACTIVITIES TO THE DATE THAT FINAL STABILIZATION
- INITIATE STABILIZATION MEASURES ON ANY EXPOSED STEEP SLOPE (3H:1V OR GREATER) WHERE LAND-DISTURBING ACTIVITIES HAVE PERMANENTLY OR
- TEMPORARILY CEASED, AND WILL NOT RESUME FOR A PERIOD OF 7 CALENDAR DAYS. MINIMIZE SOIL COMPACTION AND, UNLESS INFEASIBLE, PRESERVE TOPSOIL. MINIMIZE THE DISCHARGE OF POLLUTANTS FROM EQUIPMENT AND VEHICLE WASHING, WHEEL WASH WATER, AND OTHER WASH WATERS. WASH WATERS MUST
- BE TREATED IN A SEDIMENT BASIN OR ALTERNATIVE CONTROL THAT PROVIDES EQUIVALENT OR BETTER TREATMENT PRIOR TO DISCHARGE, MINIMIZE THE DISCHARGE OF POLLUTANTS FROM DEWATERING OF TRENCHES AND EXCAVATED AREAS. THESE DISCHARGES ARE TO BE ROUTED THROUGH APPROPRIATE BMPS (SEDIMENT BASIN, FILTER BAG, ETC.). THE FOLLOWING DISCHARGES FROM SITES ARE PROHIBITED • WASTEWATER FROM WASHOUT OF CONCRETE, UNLESS MANAGED BY AN APPROPRIATE CONTROL,
- WASTEWATER FROM WASHOUT AND CLEANOUT OF STUCCO, PAINT, FORM RELEASE OILS, CURING COMPOUNDS AND OTHER CONSTRUCTION MATERIALS, • FUELS, OILS, OR OTHER POLLUTANTS USED IN VEHICLE AND EQUIPMENT OPERATION AND MAINTENANCE, AND • SOAPS OR SOLVENTS USED IN VEHICLE AND EQUIPMENT WASHING.
- AFTER CONSTRUCTION ACTIVITIES BEGIN, INSPECTIONS MUST BE CONDUCTED AT A MINIMUM OF AT LEAST ONCE EVERY CALENDAR WEEK AND MUST BE CONDUCTED UNTIL FINAL STABILIZATION IS REACHED ON ALL AREAS OF THE CONSTRUCTION SITE. IF EXISTING BMPS NEED TO BE MODIFIED OR IF ADDITIONAL BMPS ARE NECESSARY TO COMPLY WITH THE REQUIREMENTS OF THIS PERMIT AND/OR SC'S WATER QUALITY STANDARDS, IMPLEMENTATION MUST BE COMPLETED BEFORE THE NEXT STORM EVENT WHENEVER PRACTICABLE. IF IMPLEMENTATION BEFORE THE

NEXT STORM EVENT IS IMPRACTICABLE, THE SITUATION MUST BE DOCUMENTED IN THE SWPPP AND ALTERNATIVE BMPS MUST BE IMPLEMENTED AS SOON AS

A PRE-CONSTRUCTION CONFERENCE MUST BE HELD FOR EACH CONSTRUCTION SITE WITH AN APPROVED ON-SITE SWPPP PRIOR TO THE IMPLEMENTATION OF CONSTRUCTION ACTIVITIES. FOR NON-LINEAR PROJECTS THAT DISTURB 10 ACRES OR MORE THIS CONFERENCE MUST BE HELD ON-SITE UNLESS THE DEPARTMENT HAS APPROVED OTHERWISE

ENCROACHMENT NOTES

- PRIOR TO CONSTRUCTION ALL EROSION CONTROL FEATURES SHALL BE INSTALLED PER THE SWPPP. CONTRACTOR SHALL FOLLOW ALL SCDOT APPROVED TRAFFIC CONTROL STANDARDS DURING CONSTRUCTION. EMERGENCY SERVICES (E911) SHALL BE NOTIFIED PRIOR TO ROAD CLOSURES AND/OR REROUTING. WHERE SIDEWALKS INTERSECT ROADS, HANDICAPPED RAMPS SHALL BE INSTALLED PER SCDOT AND BERKELEY
- NEW SIDEWALK TO BE INSTALLED IN ACCORDANCE WITH SCDOT STD. DRAWING 720-6 AND 720-7.

SITE DATA					
SITE ADDRESS	1000 TANNER FORD BLVD HANAHAN, SC 29410				
OWNER/DEVELOPER	THE PARK AT HANAHAN, LP 3715 NORTHSIDE PARKWAY, NW BUILDING 200, SUITE 175 ATLANTA, GA 30327 CONTACT: GARRI STEED				
CIVIL ENGINEER	SITE DESIGN, INC. 225 ROCKY CREEK ROAD GREENVILLE, SC 29615				
ARCHITECT	GEHEBER LEWIS ASSOCIATES 649 11TH ST. ATLANTA, GA 30318				
ZONING	RM (MULTIFAMILY RESIDENTIAL)				
PROPOSED USE	INDEPENDENT LIVING 48 - 1BR UNITS 24 - 2BR UNITS				
TAX MAP #	PART TM# 2590000145				
PARCEL AREA	3.15 ACRES				
SETBACKS	FRONT: 15' SIDES: 20' REAR: 25'				

SHEET INDEX

SHEET NUMBER
1
2
3
4
5
6
7
8
9
10
11
12
13
14

CONSTRUCTION SCHEDULE

					M	НТИС						
TASKS	1	2	3	4	5	6	7	8	9	10	11	12
DETERMINE LIMITS OF CONST.	Н											
INSTALL CONSTRUCTION ENTRANCE	Н											
CLEAR AND GRUB SITE		T										
GRADE SITE AREAS	H	7										
INSTALL STORM DRAIN		<u> </u>		\vdash								
HOUSE CONSTRUCTION		\vdash										H
PAVING OPERATIONS			-	H								
FINAL GRASSING AND LANDSCAPING											\vdash	Н
REMOVE EROSION CONTROL MEASURES												Н
MAINT. OF SED AND EROSION												
CLOSEOUT PERMIT												Н



Y THE CONTRACTOR SHALL BE THE SOLE RESPONSIBILITY OF THE CONTRACTOR.


THE UTILITIES SHOWN ARE SHOWN FOR THE CONTRACTOR'S CONVENIENCE ONLY. THERE MAY BE OTHER UTILITIES NOT SHOWN ON THESE PLANS. THE ENGINEER ASSUMES NO RESPONSIBILITY FOR THE LOCATIONS SHOWN AND IT SHALL BE THE CONTRACTOR'S RESPONSIBILITY TO VERIFY THE LOCATIONS OF ALL UTILITIES WITHIN THE LIMITS OF THE WORK. ALL DAMAGE MADE TO EXISTING UTILITIES

TOTAL SITE DISTURBANCE: 2.8 ACRES

24-HOUR CONTACT GARRI STEEDE 470-453-8900

SITE DESIGN, INC.


CIVIL ENGINEERS - SURVEYORS - LANDSCAPE ARCHITECTS

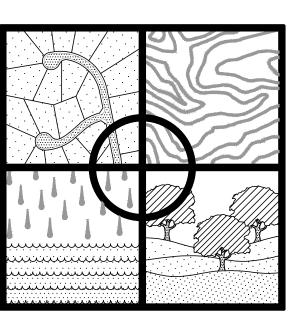


www.sitedesign-inc.com 225 ROCKY CREEK RD GREENVILLE, SC 29615 PH: (864)271-0496

THE PARK AT HANAHAN

SEAL	C.O.A.		RE	VISIC	NS		
		10.					
		9.					
C MINING PESSION OF THE PROPERTY OF THE PROPER	WILL CARO	8.					
	SITE DESIGN	7.					
S JUNIO FESSION PRINTED TO	SITE DESIGN	6.					
EXON EXACT IN THE PROPERTY OF		5.					
* No. 24201		4.					
1 D.W. DOS	No. C00122 //	3.					
F. W. W. W. W. L.		2.					
T BONING	OF AUTHORITI	1.					
Think T. 18/201			SHEET NUMBER	1	OF	XX	

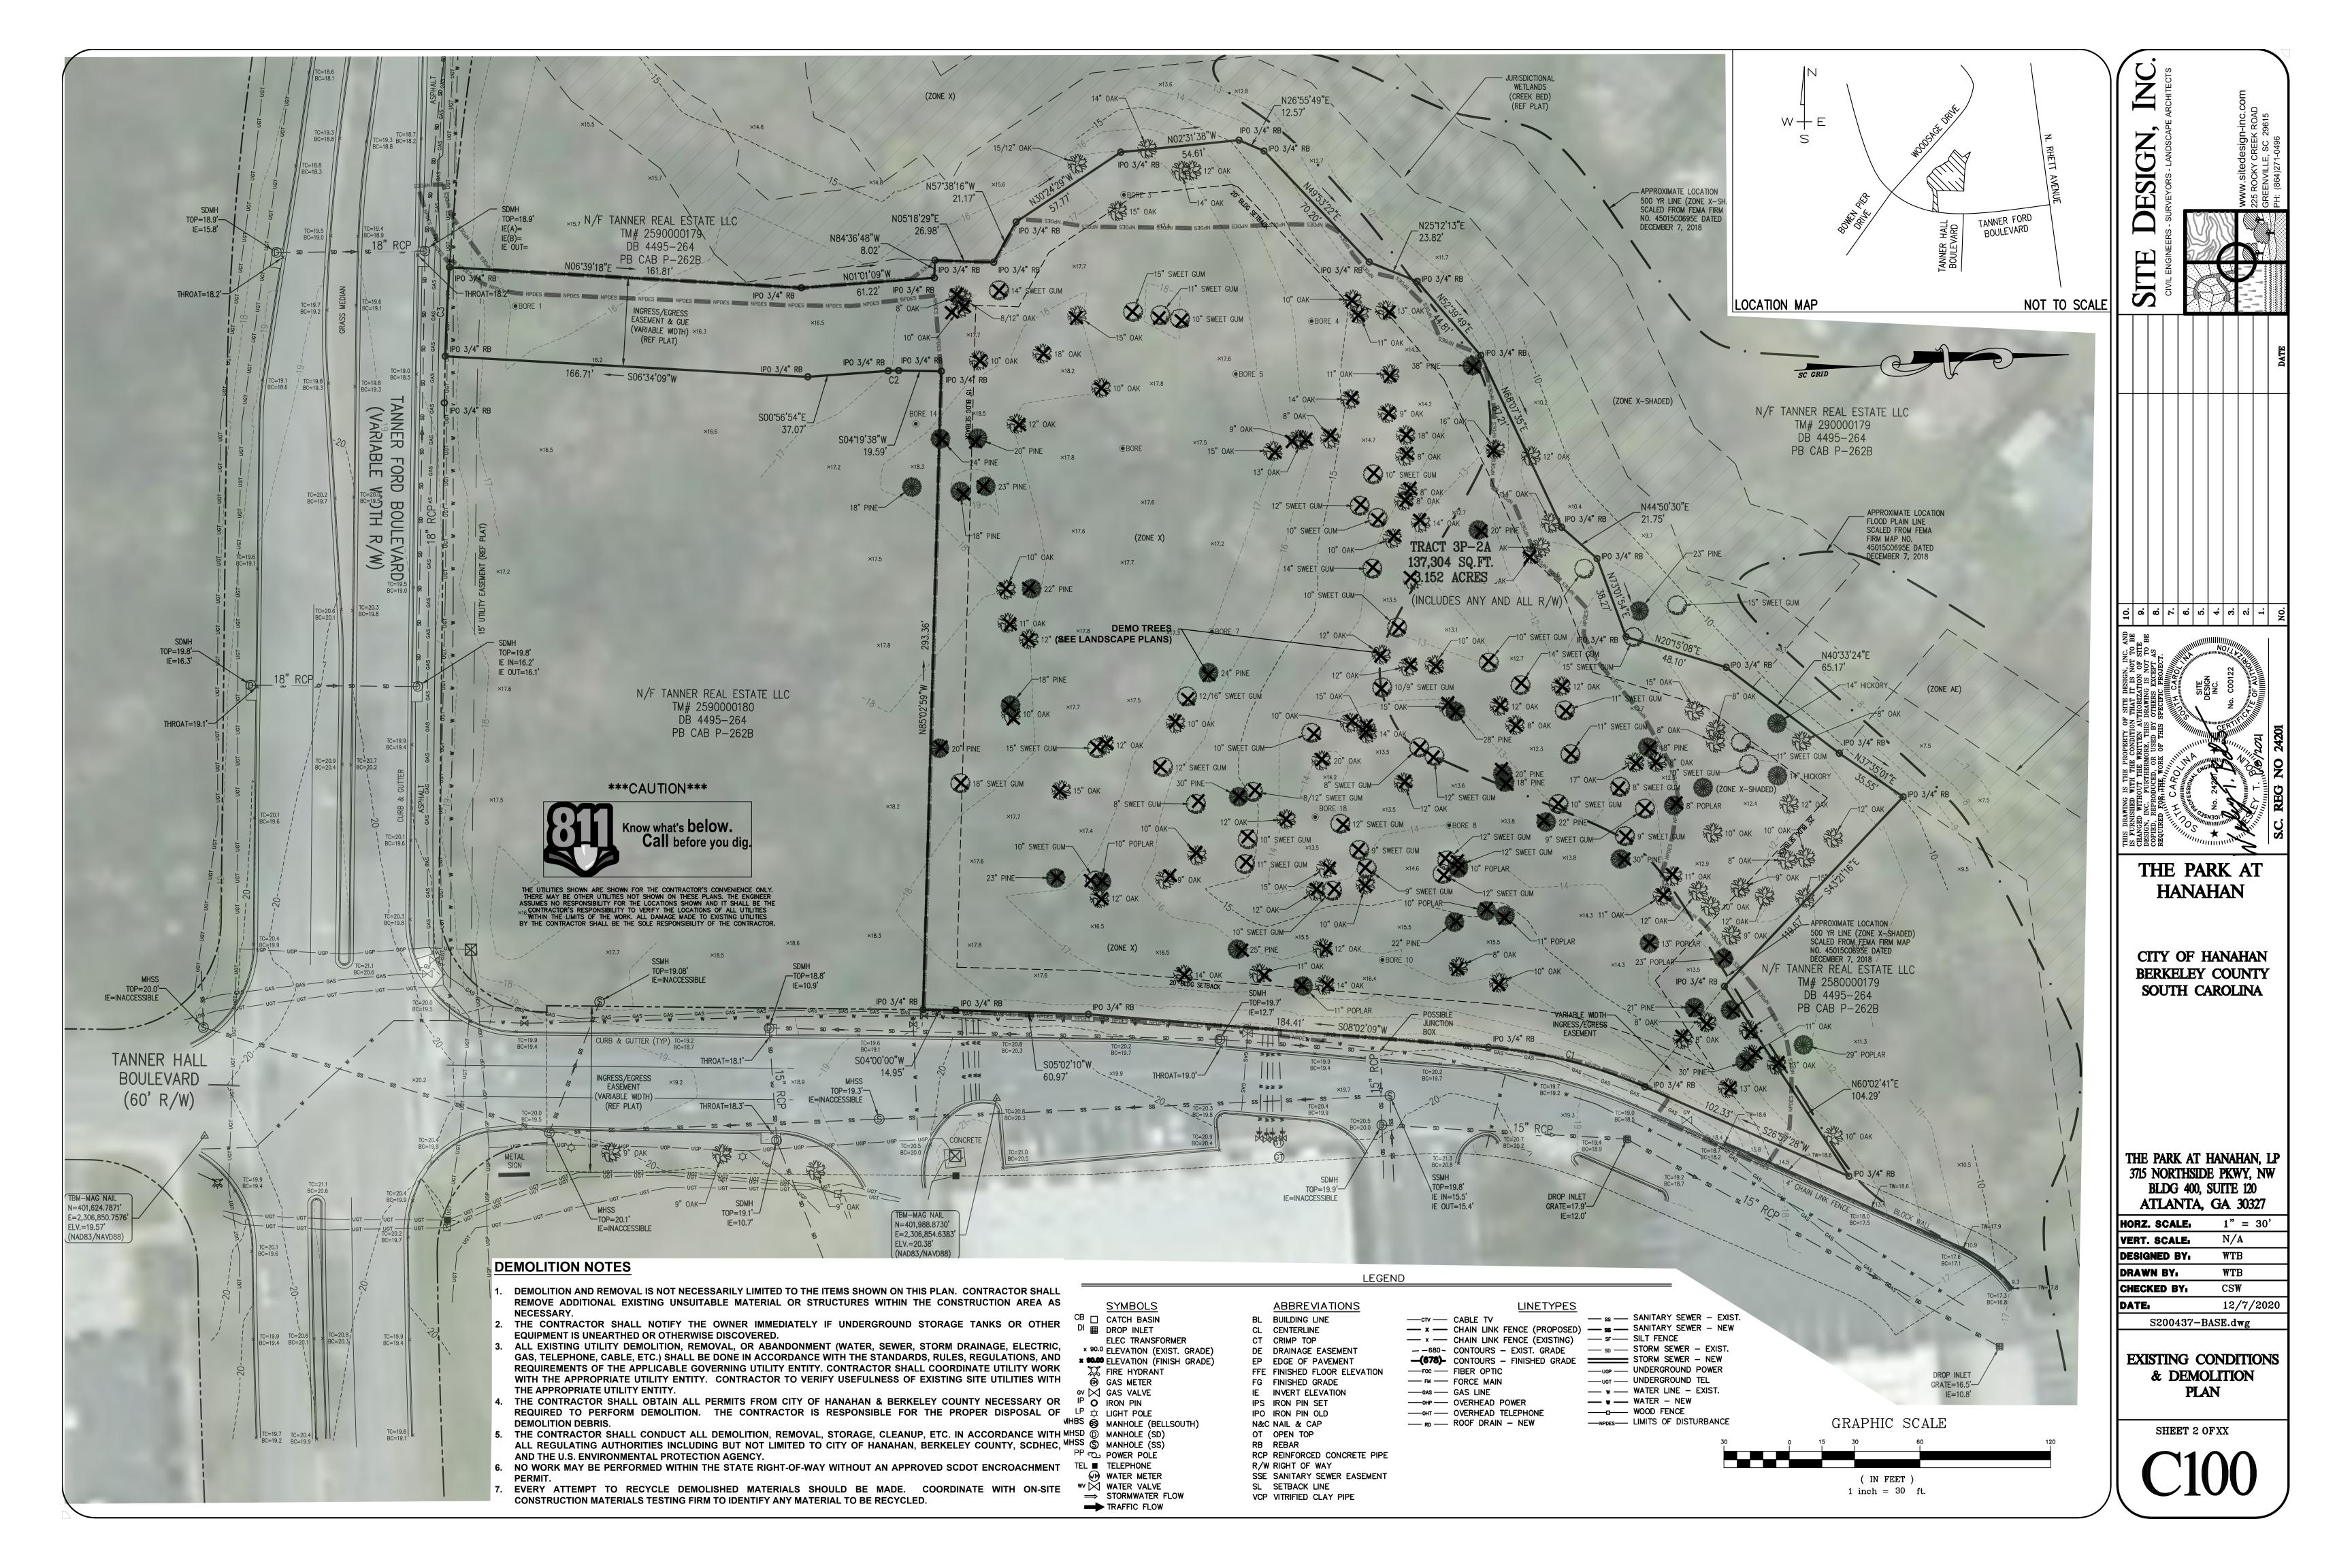

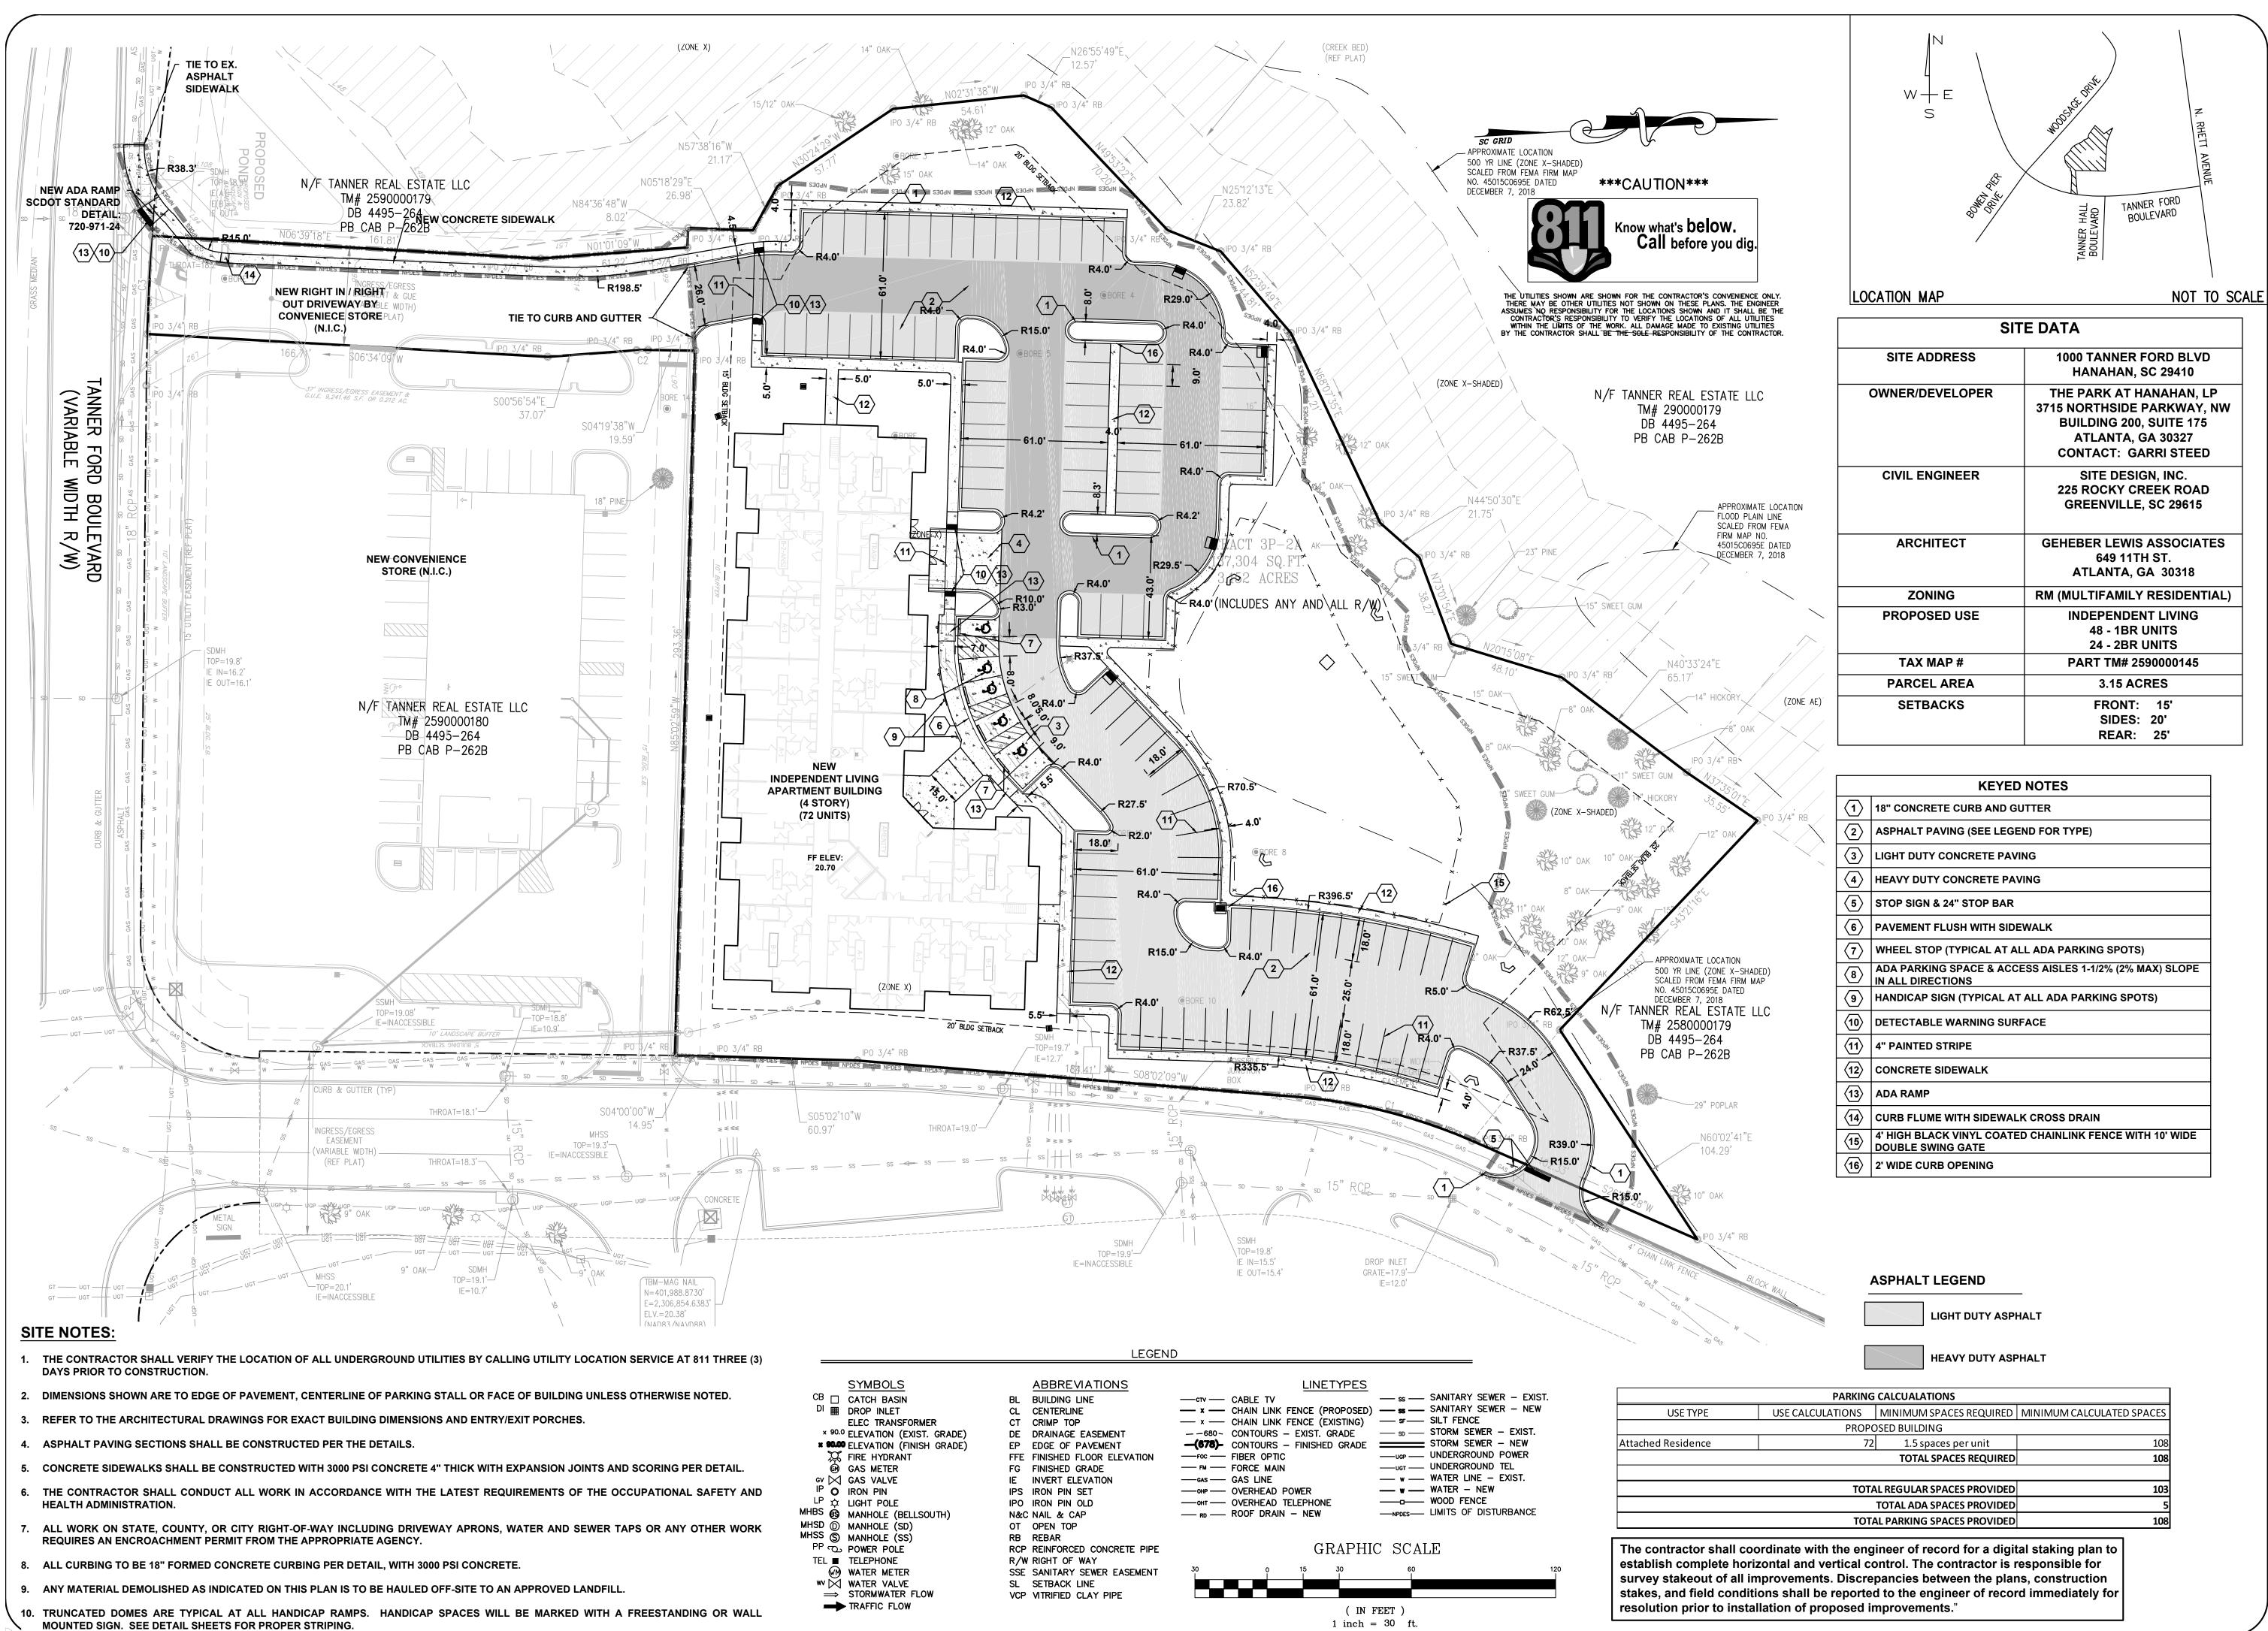

CIVIL ENGINEERS - SURVEYORS - LANDSCAPE ARCHITECTS

CIVIL ENGINEERS - SURVEYORS - LANDSCAPE ARCHITECTS

WWW. sitedesign-inc. com

225 ROCKY CREEK ROAD

GREENVILLE, SC 29615

PH: (864)271-0496

THIS DRAWING IS THE PROPERTY OF SITE DESIGN, INC. AND IS FURNISHED WITH THE CONDITION THAT IT IS NOT TO BE CHANGED WITHOUT THE WRITTEN AUTHORIZATION OF SITE DESIGN, INC. FURTHERMORE, THIS DRAWING IS NOT TO BE COPIED, REPRODUCED, OR USED BY OTHERS EXCEPT AS REQUIRED, RORR ITHE SPECIFIC PROJECT.

REQUIRED REPRODUCED, OR USED BY OTHERS EXCEPT AS REQUIRED, RORR ITHE SPECIFIC PROJECT.

A. CAROLINIA CAROLINIA

THE PARK AT HANAHAN

CITY OF HANAHAN
BERKELEY COUNTY
SOUTH CAROLINA

THE PARK AT HANAHAN, LP 3715 NORTHSIDE PKWY, NW BLDG 400, SUITE 120 ATLANTA GA 30327


AILANIA,	GA 30321
HORZ. SCALE:	1" = 30'
VERT. SCALE:	N/A
DESIGNED BY.	WTB
DRAWN BY	WTB
CHECKED BY.	CSW
DATE:	12/7/2020


E₁ 12/7/20 S200437-BASE.dwg

> SITE PLAN

SHEET 3 OF XX

C200

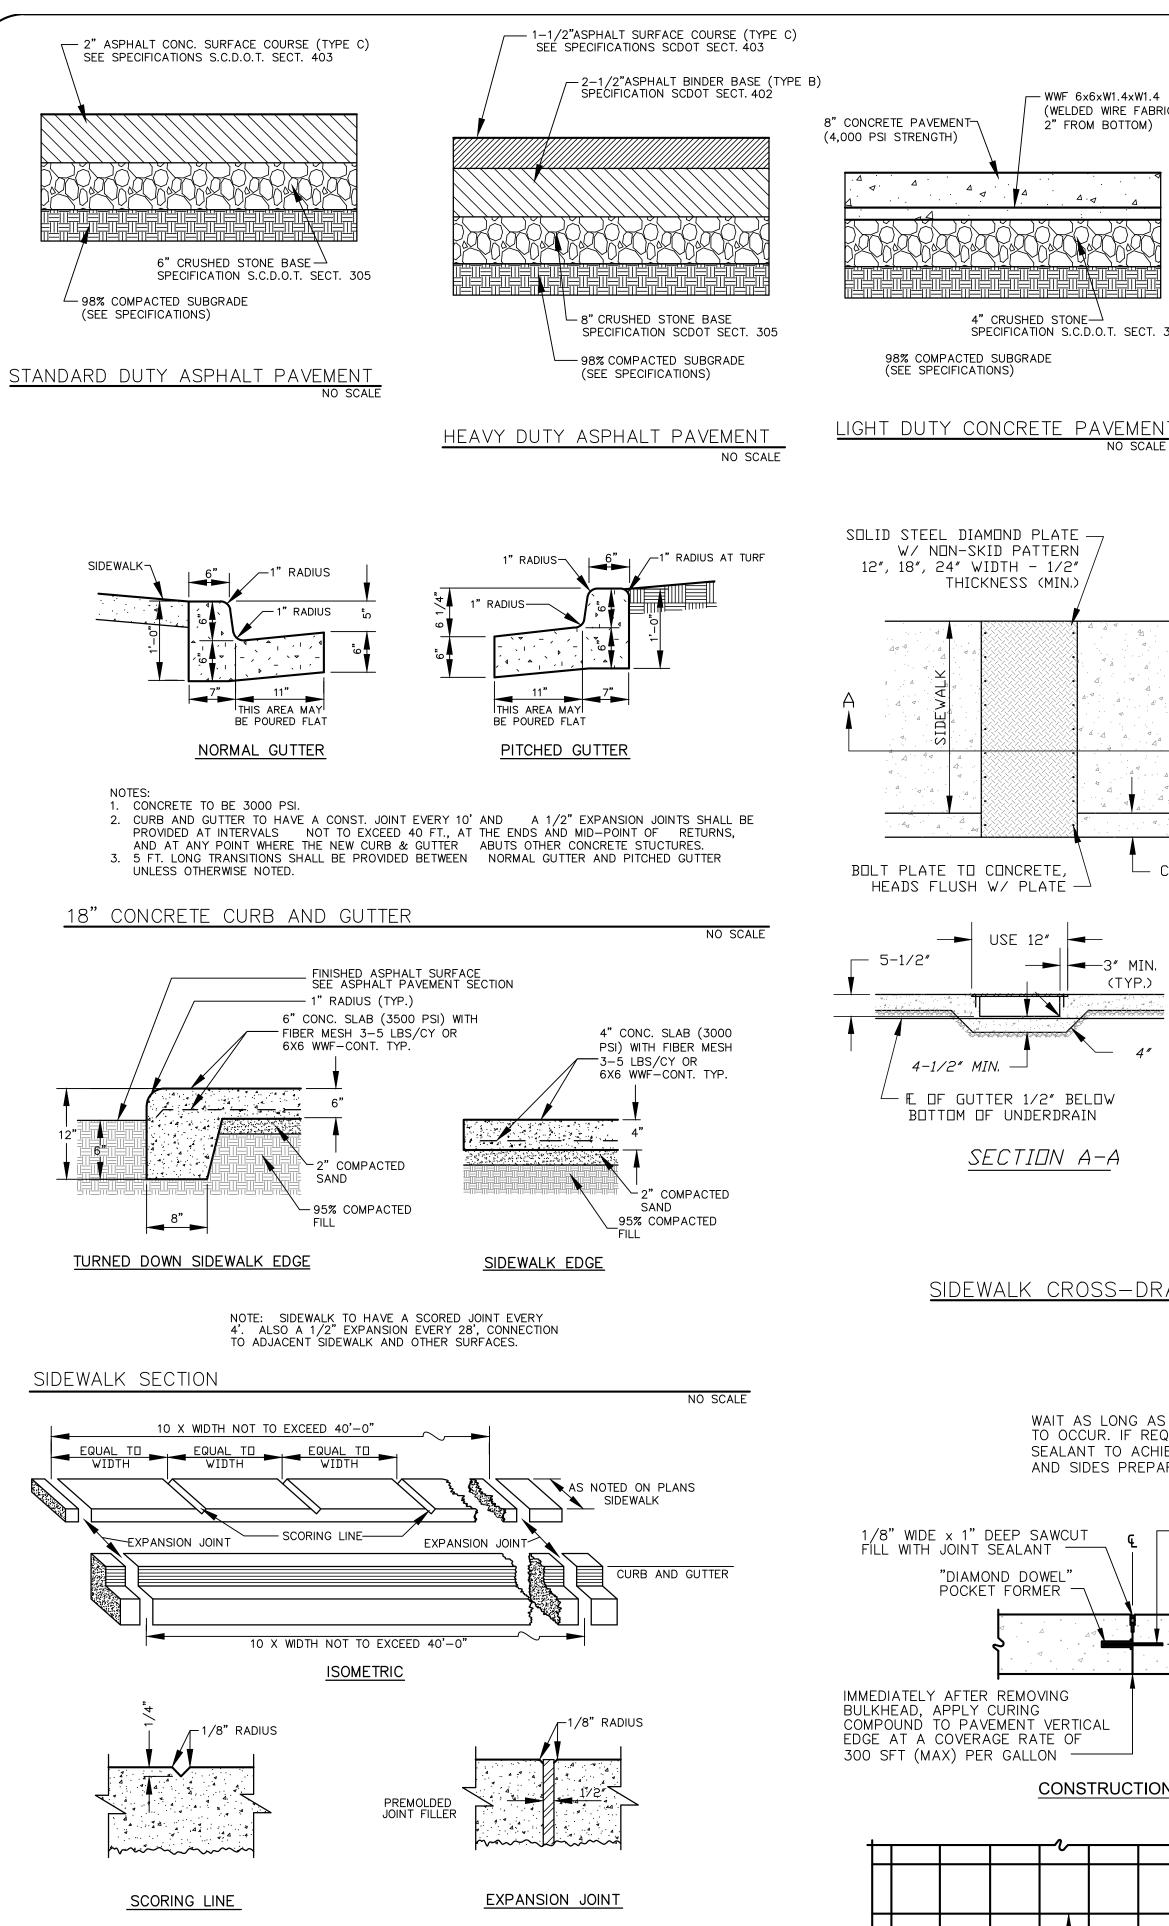

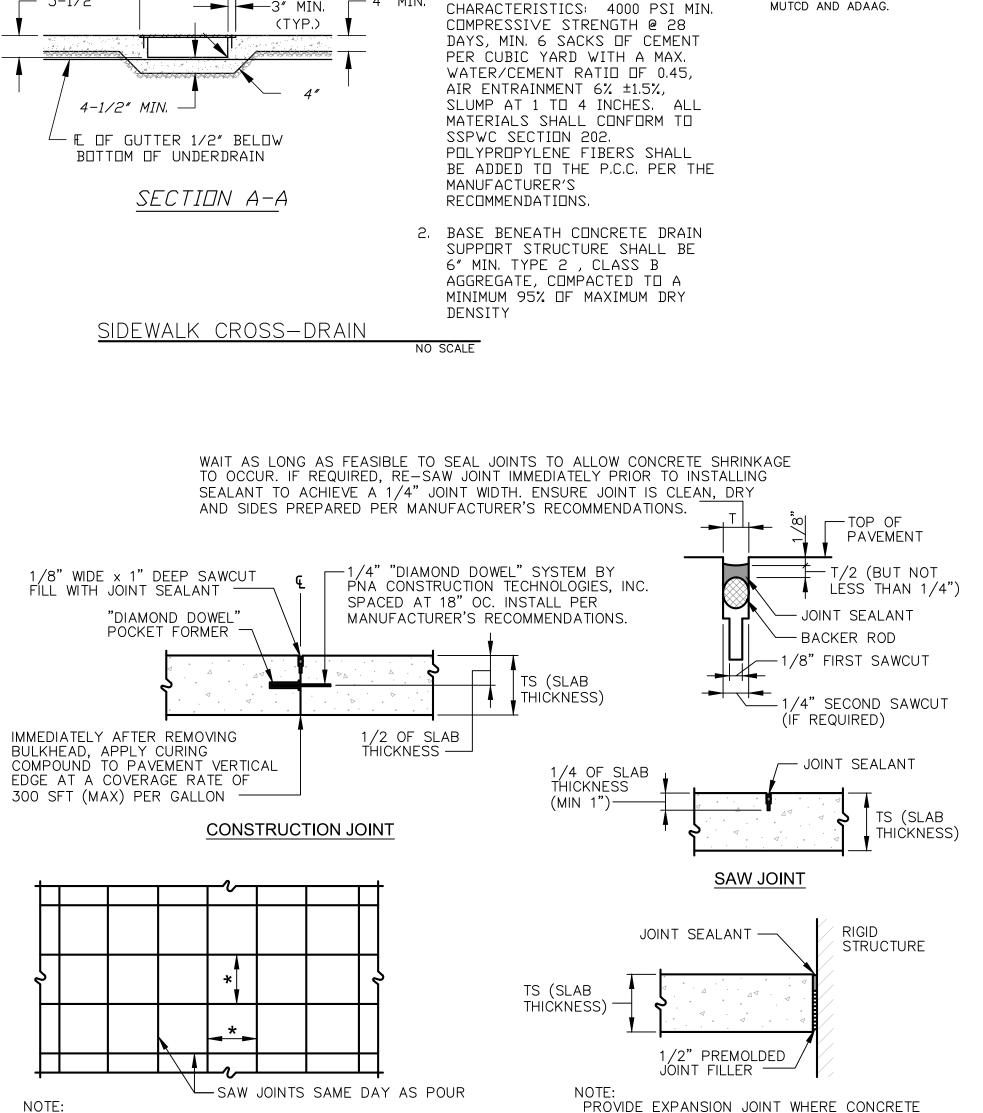

PAVEMENT ABUTS A RIGID STRUCTURE.

EXPANSION JOINT

___ WWF 6x6xW1.4xW1.4

2" FROM BOTTOM)

4" CRUSHED STONE—
SPECIFICATION S.C.D.O.T. SECT. 305

└─ CURB

⊸3″ MIN.

*JOINT SPACING = 30 x TS (SLAB THICKNESS)

CONCRETE PAVEMENT (PLAN VIEW)

THICKNESS (MIN.)

(WELDED WIRE FABRIC -

12" CONCRETE PAVEMENT

(4,000 PSI STRENGTH)

— WWF 6x6xW1.4xW1.4

2" FROM BOTTOM)

A . A

SPECIFICATION S.C.D.O.T. SECT. 305

4" CRUSHED STONE-

HEAVY DUTY CONCRETE PAVEMENT

98% COMPACTED SUBGRADE


1. FIBER-REINFORCED PORTLAND

HAVE THE FOLLOWING

CEMENT CONCRETE (P.C.C.) SHALL

(SEE SPECIFICATIONS)

(WELDED WIRE FABRIC -

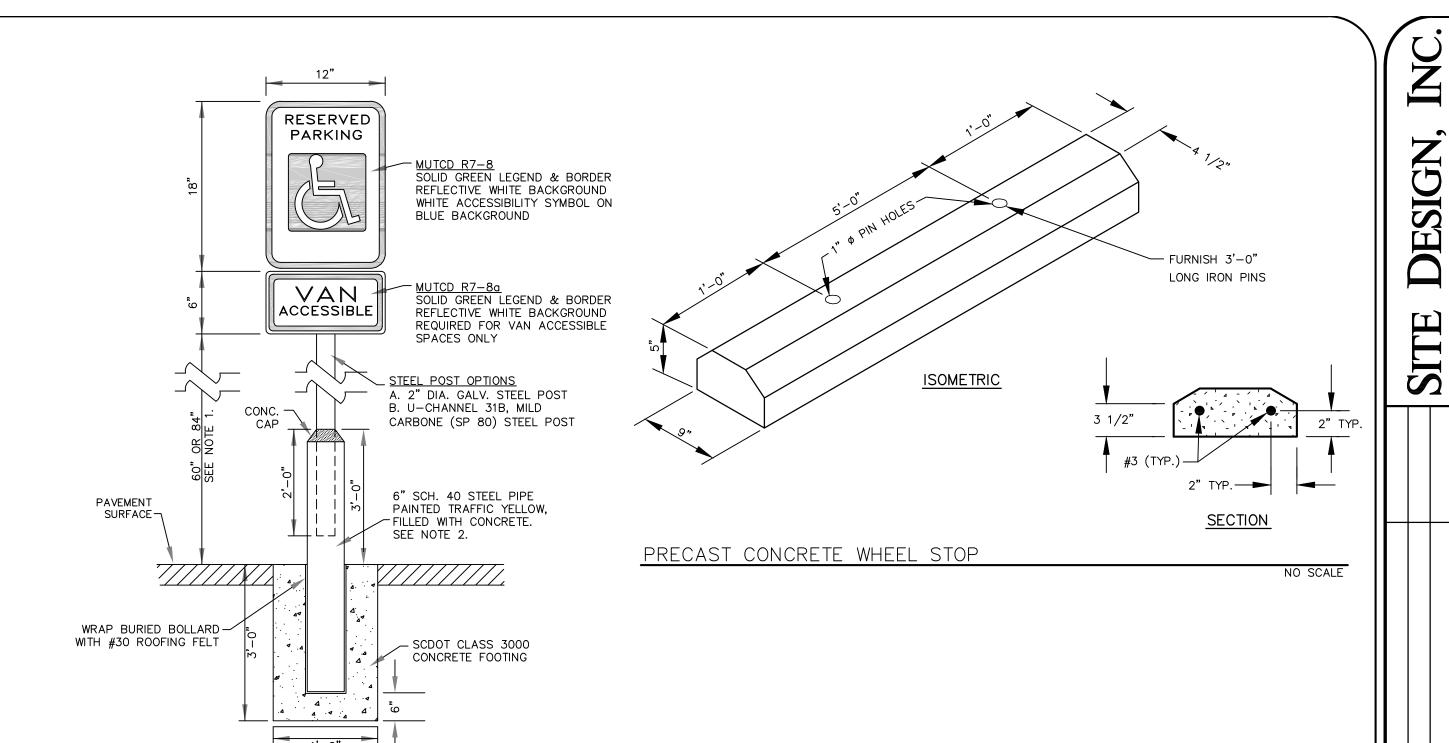


1. 12"x18" ACCESSIBILITY SIGN (R7-8) SHALL BE MOUNTED 7' FROM FINISH GRADE TO BOTTOM EDGE OF SIGN FACE. MOUNTING HEIGHT MAY BE REDUCED TO 5' IF PLACED IN A LANDSCAPE AREA IN WHICH PEDESTRIANS ARE NOT

2. BOLLARD MAY BE OMITTED IF INSTALLED IN LANDSCAPE AREAS. WHEN INSTALLED IN LANDSCAPE AREAS, MOUNTING POST SHALL BE DRIVEN A MINIMUM OF 3' BELOW FINISH GRADE. ALTERNATE MOUNTING POSTS MUST BE APPROVED BY THE CITY ENGINEER PRIOR TO CONSTRUCTION.

3. SIGNAGE SHALL BE INSTALLED IN FRONT OF EACH ACCESSIBLE SPACE, CENTERED ON THE WIDTH OF THE SPACE. 4. REFER TO AMERICANS WITH DISABILITIES ACT AND ARCHITECTURAL BARRIERS ACT ACCESSIBILITY GUIDELINES (ADAAG), LATEST EDITION, FOR REQUIRED NUMBER OF ACCESSIBLE SPACES. PER ADAAG, ONE VAN ACCESSIBLE SPACE SHALL BE PROVIDED, MINIMUM, WITH ADDITIONAL VAN ACCESSIBLE SPACES PER ADAAG REQUIREMENTS.

5. ALL SIGNAGE SHALL BE ENGINEER GRADE .080 ALUMINUM REFLECTIVE SIGN MEETING THE REQUIREMENTS OF THE MUTCD AND ADAAG.

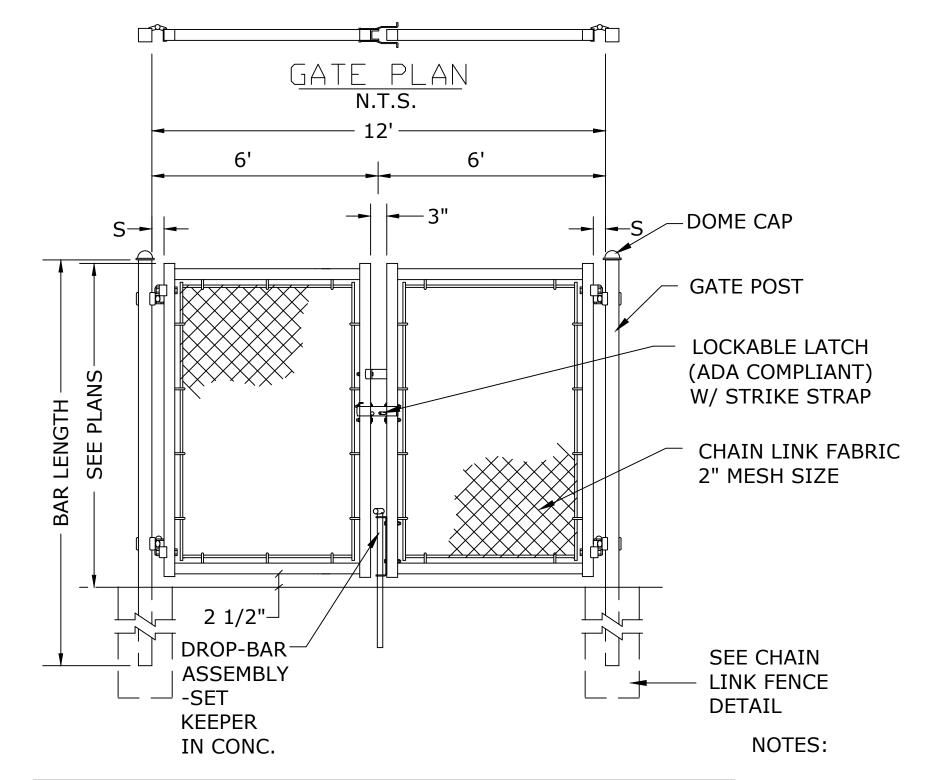

DOUBLE LEAF GATES							
OPENING	GATE POSTS	HINGE SPACE (S)					
FACE TO FACE	RND SIZES	POST TO UPRIGHT					
8'-0" THROUGH 12'-0"	2 7/8" OR 2.875" OD	FOR ROUND GATE POSTS: 2 7/8"					

DOUBLE GATE ELEVATION

N.T.S.

THE PARK AT

HANAHAN

CITY OF HANAHAN

BERKELEY COUNTY

SOUTH CAROLINA

THE PARK AT HANAHAN, LP

3715 NORTHSIDE PKWY, NW

BLDG 400, SUITE 120

ATLANTA, GA 30327

S200437-DETAIL.dwg

SITE

DETAILS

SHEET 4 OF XX

N/A

N/A

WTB

WTB

CSW

1/8/2021

HORZ. SCALE:

VERT. SCALE:

DESIGNED BY.

CHECKED BY:

DRAWN BY

- 2. ALL CHAIN LINK FENCE POSTS, RAILS, FABRIC, HARDWARE AND FITTINGS TO BE CLASS II B THERMALLY FUSED AND BONDED PVC COATING COLOR: BLACK
- CONTRACTOR TO SUBMIT SHOP **DRAWINGS**

MATERIALS AND METHOD OF
CONSTRUCTION SHALL CONFORM
TO CHAIN LINK FENCE DETAIL ON
THIS SHEET.

SIDEWALK EXPANSION JOINTS & SCORING LINES

3. LONGITUDINAL SCORING LINES WILL BE REQUIRED IN WALKS WIDER THAN SIX FEET.

OF DRIVEWAYS, AND UNIFORM INTERVALS AS SHOWN.

1. EXPANSION JOINTS, 3/4" THICK, SHALL BE PLACED AT THE P.C. AND P.T. OF ALL CURVES, AT THE OUTER EDGES


4. CONCRETE SHALL BE "READY MIX" HAVING A 28 DAY COMPRESSIVE STRENGTH OF 3000 P.S.I. AND AIR ENTRAINED.

5. FORMS SHALL BE INSPECTED BY THE PROPER AUTHORITY GRADE AND ALIGNMENT BEFORE PLACING CONCRETE. 6. SIDEWALKS SHALL NOT CROSS DRIVEWAYS; THE CONTRACTOR SHALL INSTALL THE DRIVEWAY BEFORE THE SIDEWALK,

2. JOINTS IN THE CURB AND GUTTER SHALL ALIGN WITH CORRESPONDING JOINTS IN THE SIDEWALK.

OR SHALL SAWCUT AND REMOVE THE SIDEWALK IF INSTALLING THE DRIVEWAY AFTER THE SIDEWALK.

NO SCALE

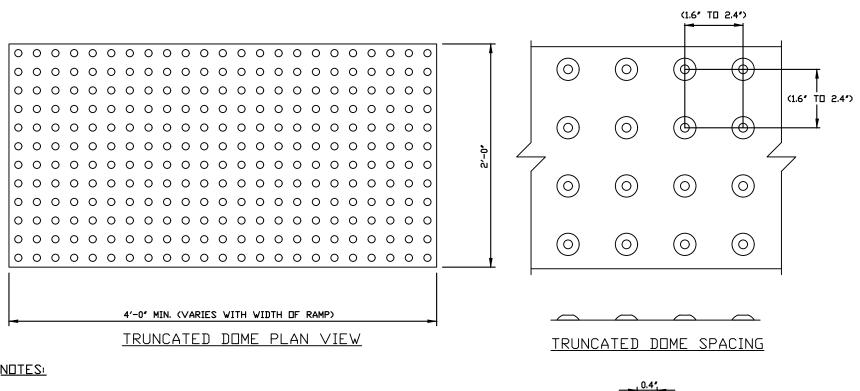



TRUNCATED DOME SECTION


NOTES:


- 1. DETECTABLE WARNINGS SHALL BE CAST IN PLACE, COLOR: BRICK RED AS MANUFACTURED BY ARMOR TILE, INSTALLED PER MANUFACTURERS SPECIFICATIONS.
- 2. WIDTH OF DETECTABLE WARNING AREA SHALL BE A MINIMUM OF 4 FEET AND VARY WITH WIDTH OF RAMP OR AS SHOWN ON PLANS. 3. LENGTH OF DETECTABLE WARNING AREA SHALL BE 2 FEET
- REGARDLESS OF SECTION WIDTH. 4. DETECTABLE WARNING AREA CAN BE SQUARE WHERE USED IN A CURB RADIUS.
- 5. DETECTABLE WARNING DOMES SHALL BE ALIGNED ON A SQUARE GRID IN THE PREDOMINANT DIRECTION OF OF TRAVEL TO PERMIT
- WHEELS TO ROLL BETWEEN DOMES. 6. DETECTABLE WARNING AREA SHALL BE COLORED SAFETY YELLOW IN DOT ROW.

TRUNCATED DOME SURFACE N.T.S.

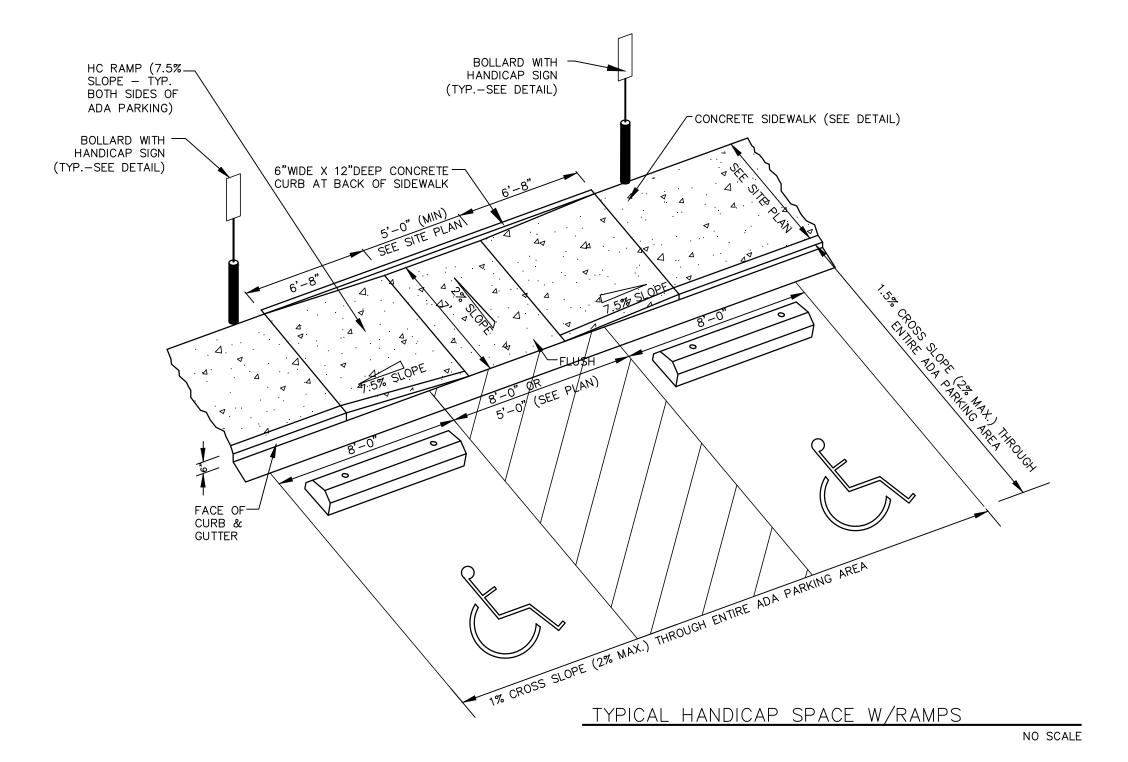

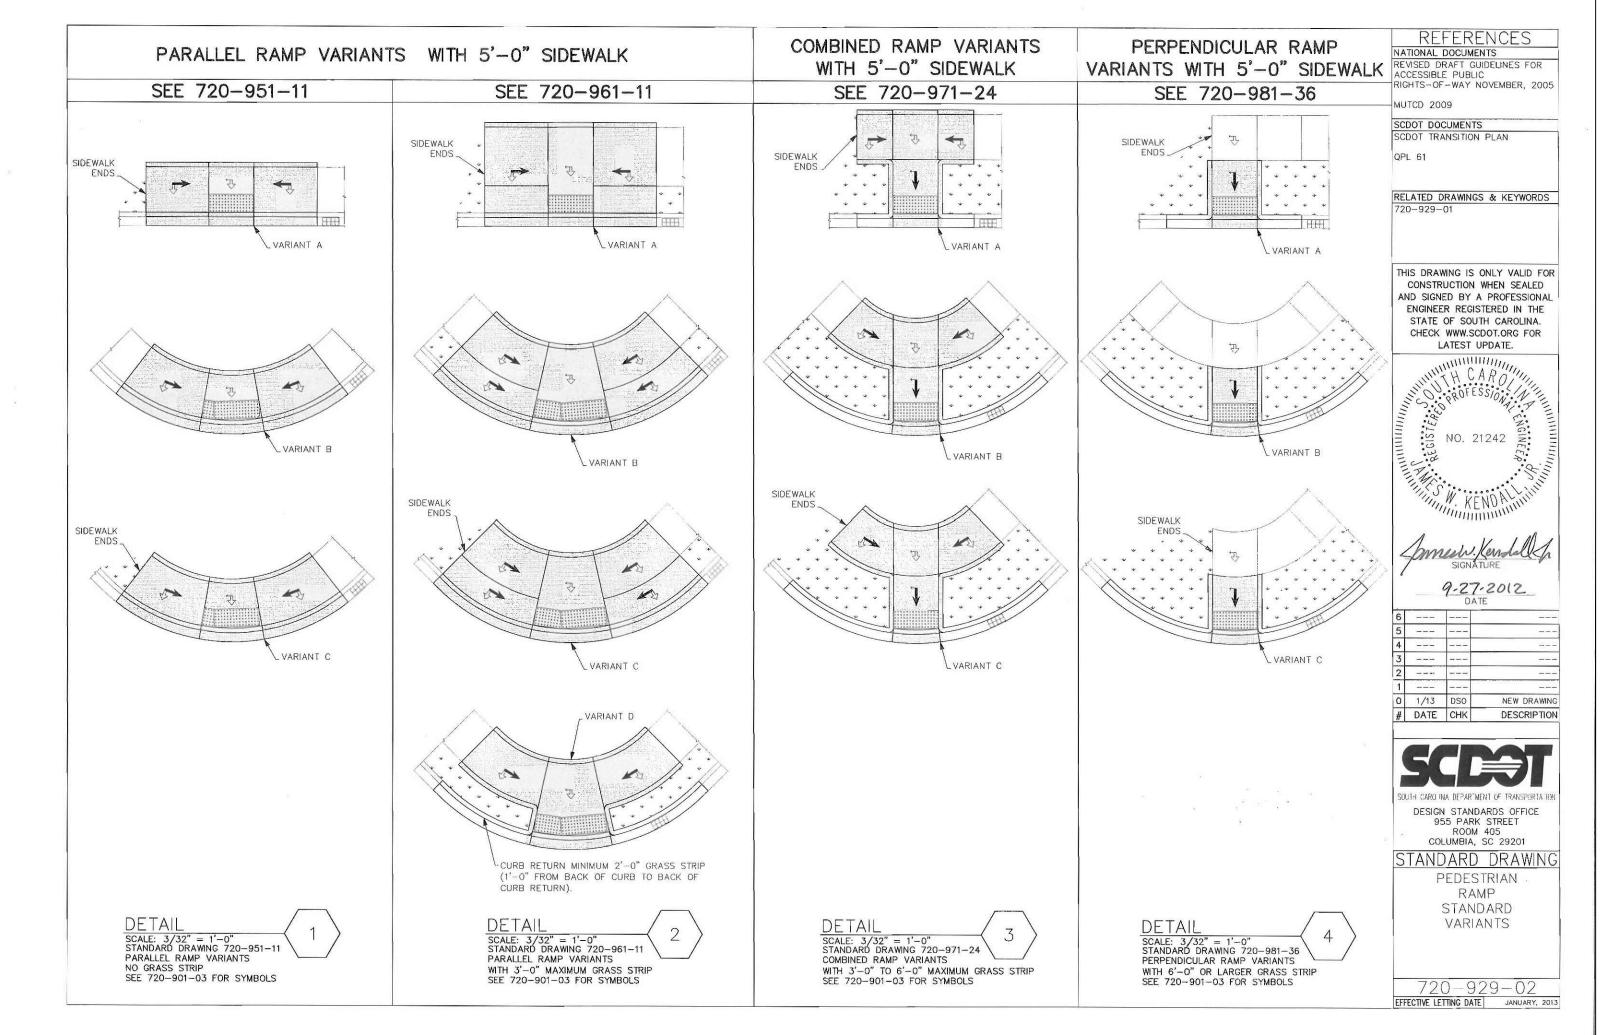

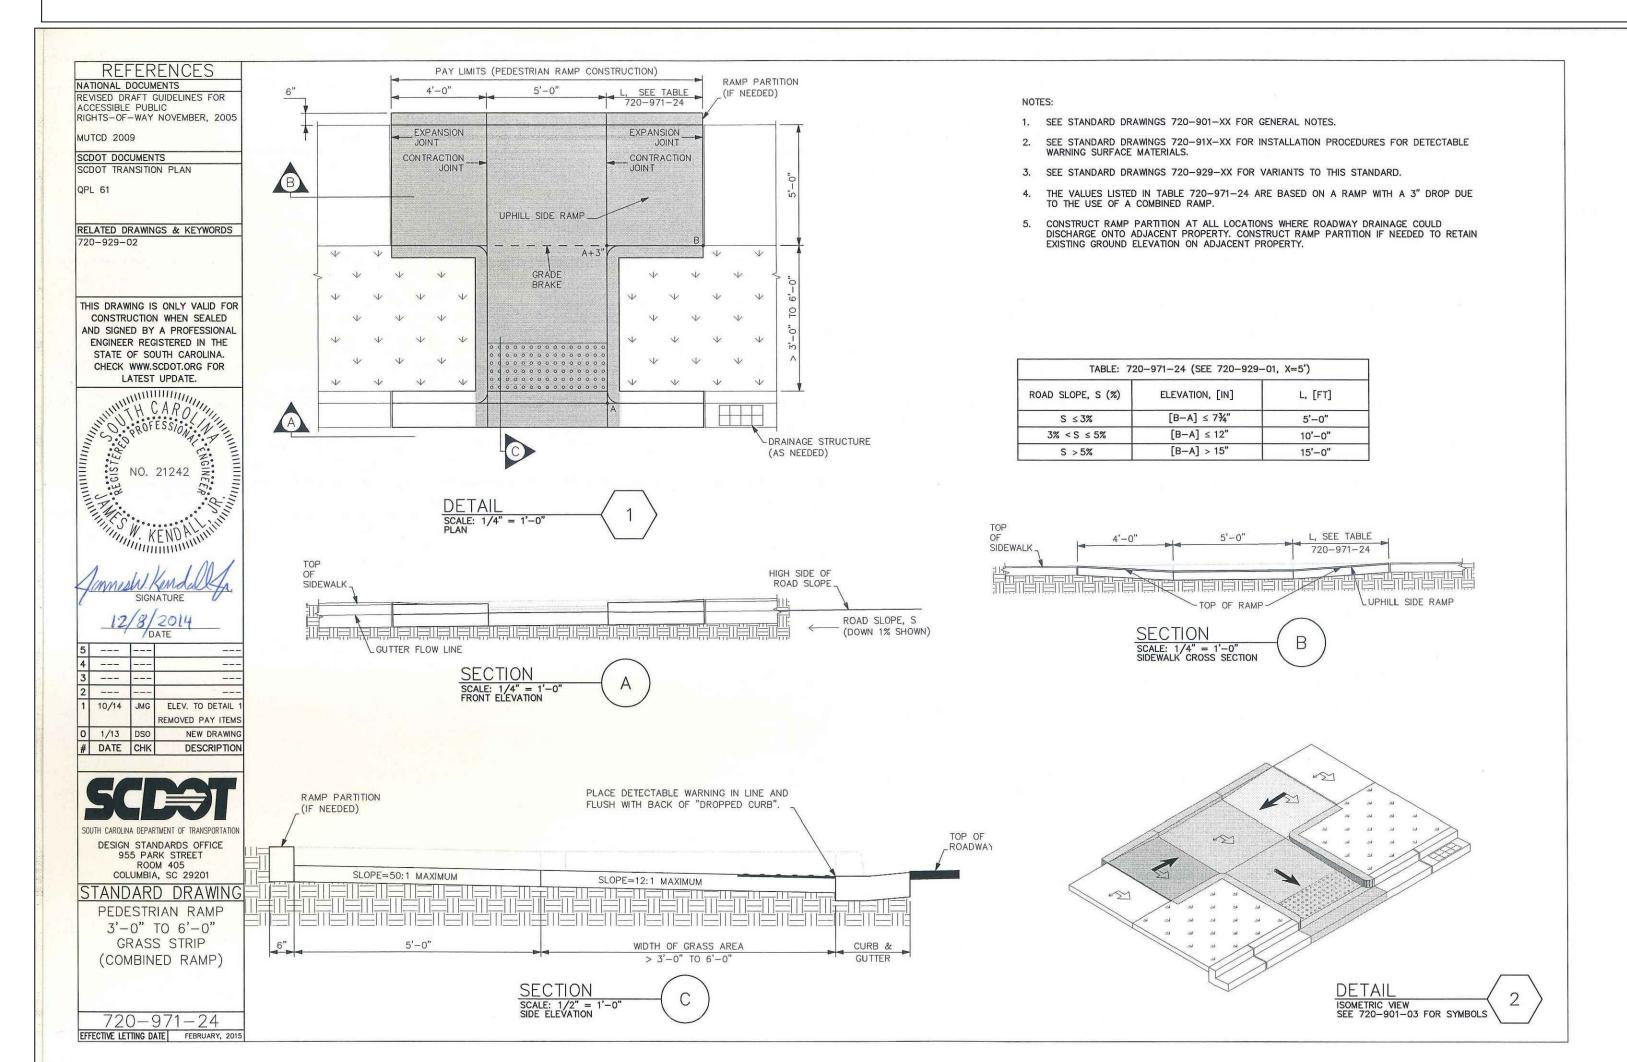

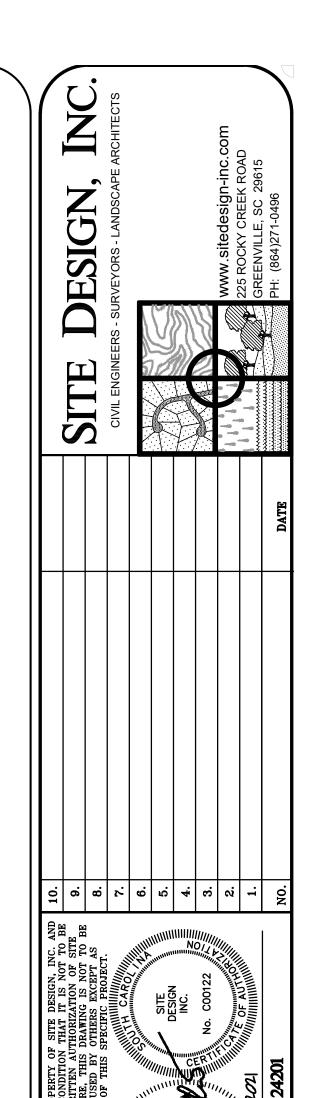

THE PARK AT **HANAHAN**


CITY OF HANAHAN BERKELEY COUNTY SOUTH CAROLINA


THE PARK AT HANAHAN, LP 3715 NORTHSIDE PKWY, NW BLDG 400, SUITE 120

ATLANTA,	GA 30327				
IORZ. SCALE:	N/A				
/ERT. SCALE:	N/A				
DESIGNED BY.	WTB				
DRAWN BY	WTB				
CHECKED BY.	CSW				
DATE	1/8/2021				
S200437-DETAIL.dwg					


SITE **DETAILS**

SHEET 5 OF XX

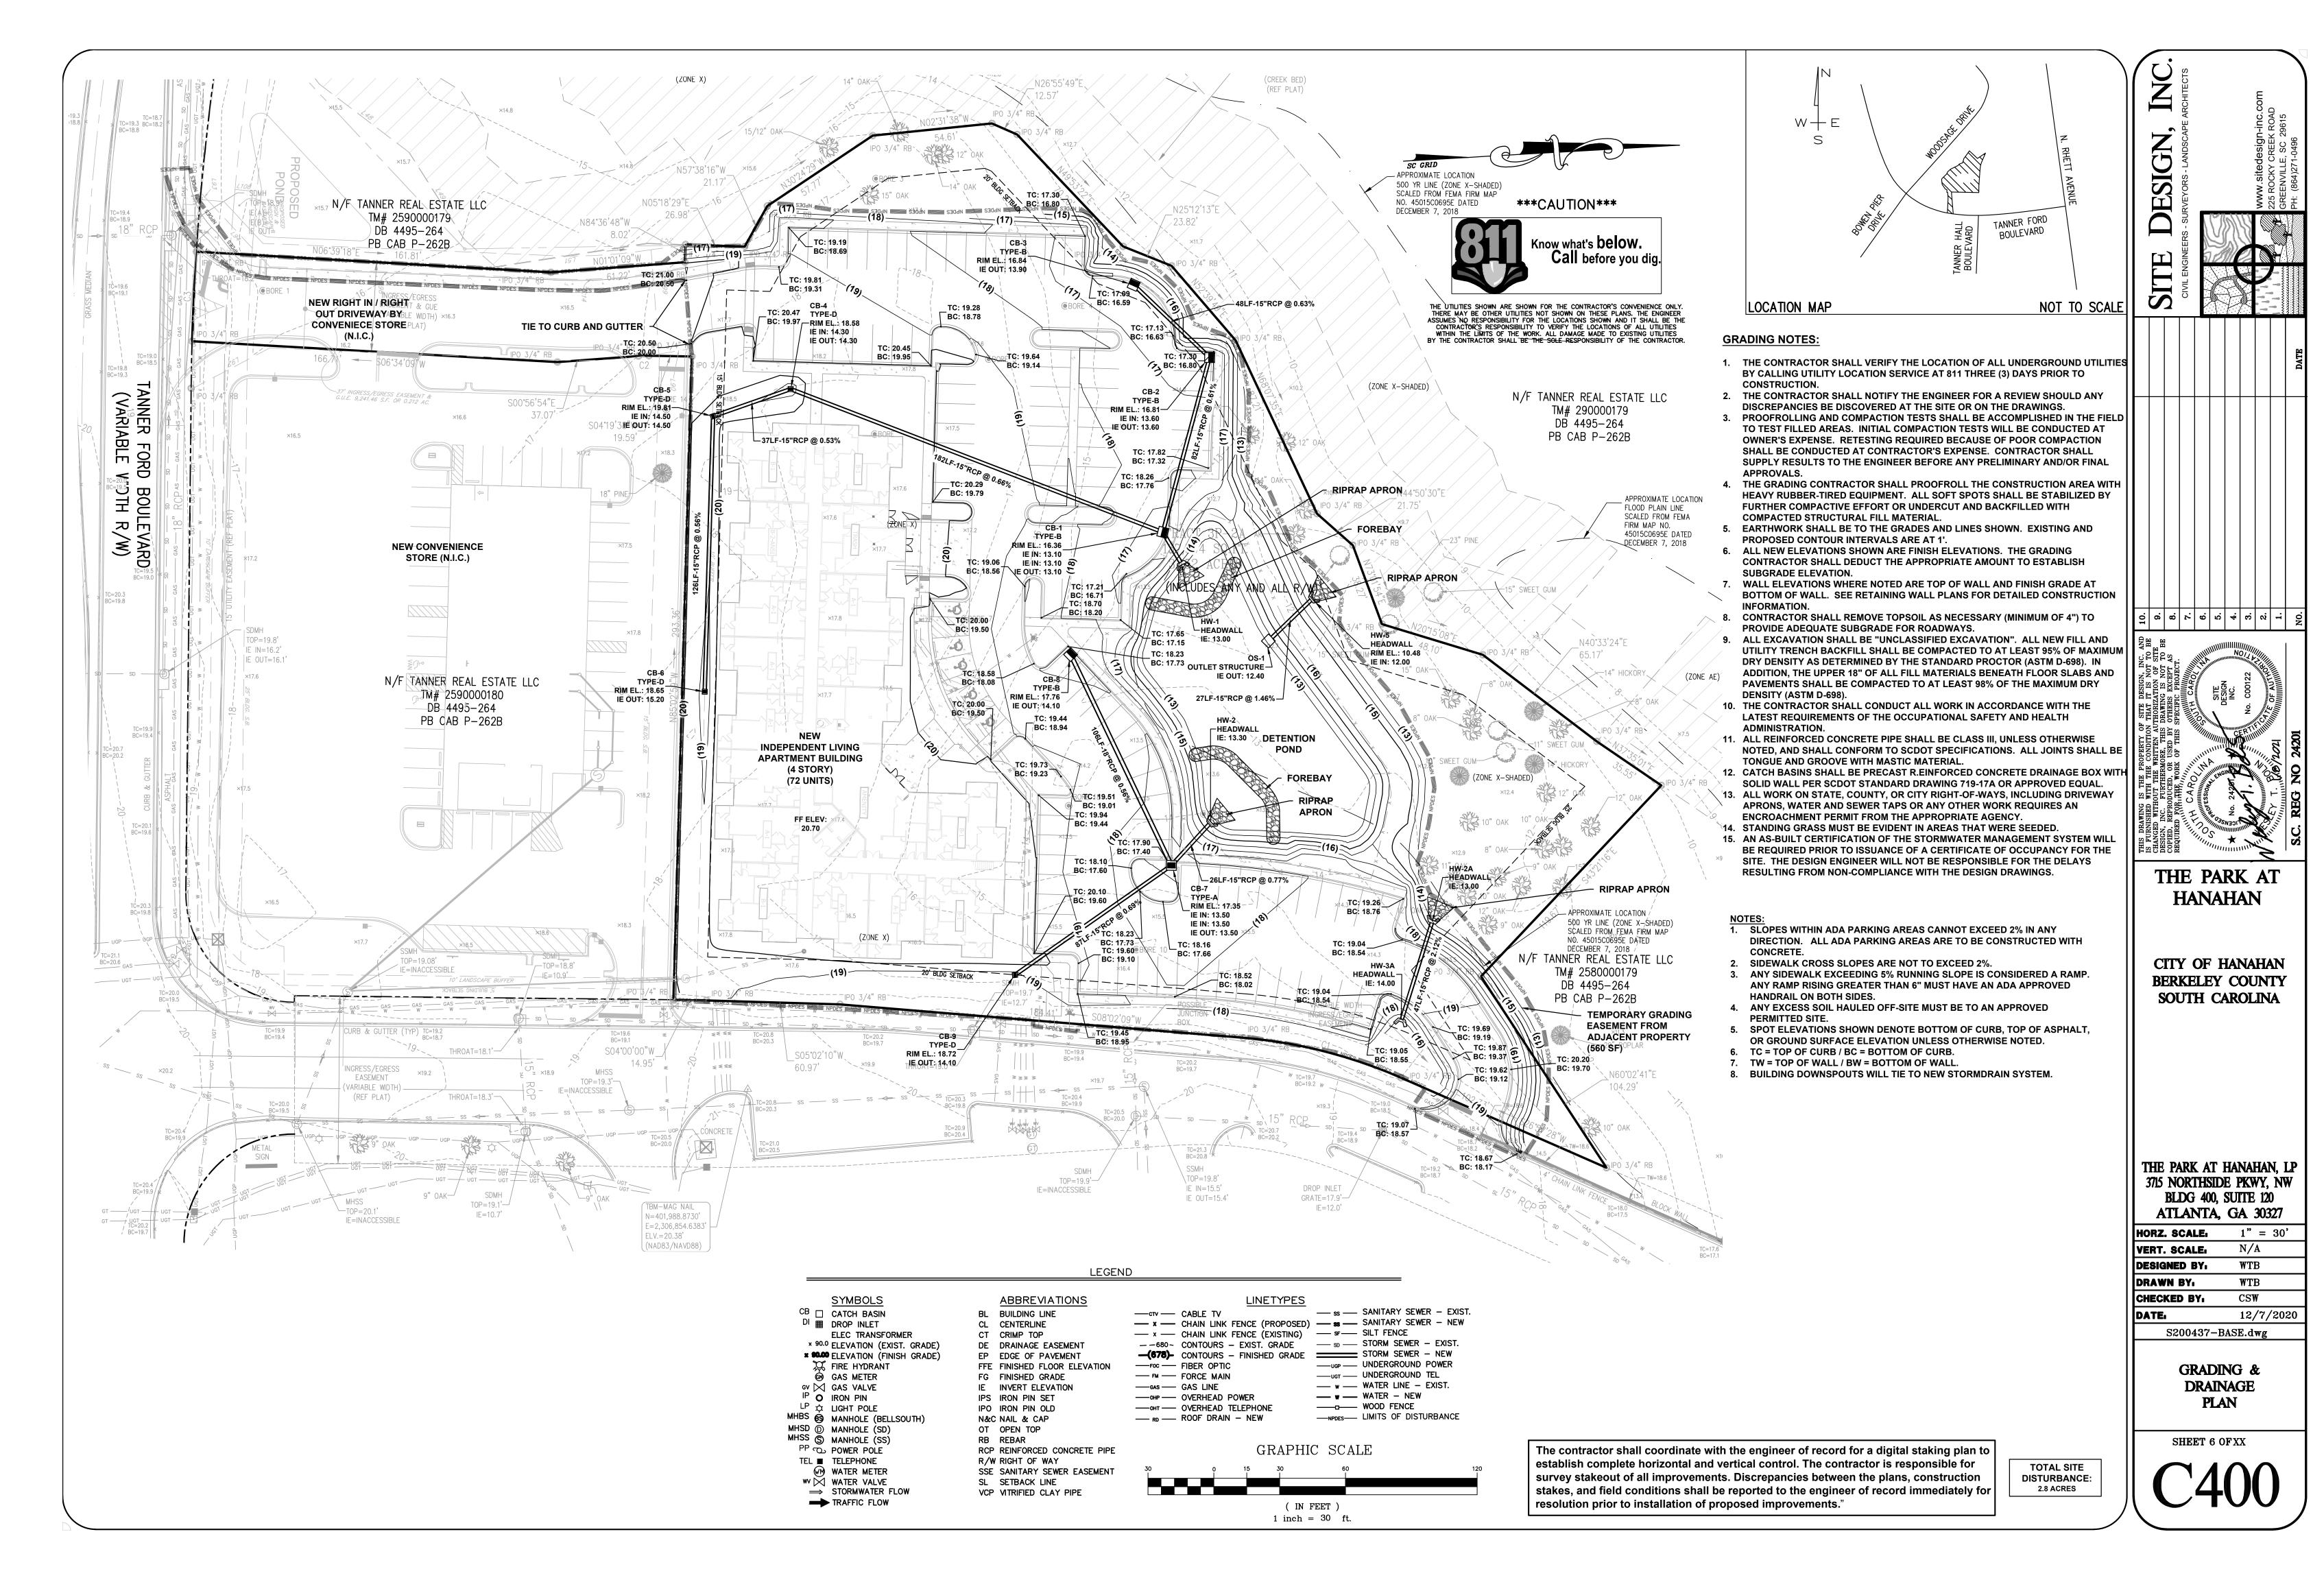

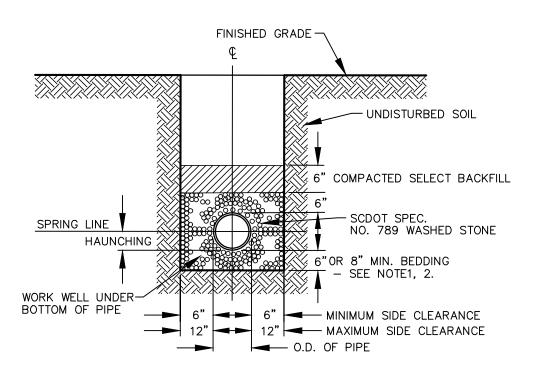


PVC & HDPE SEWER

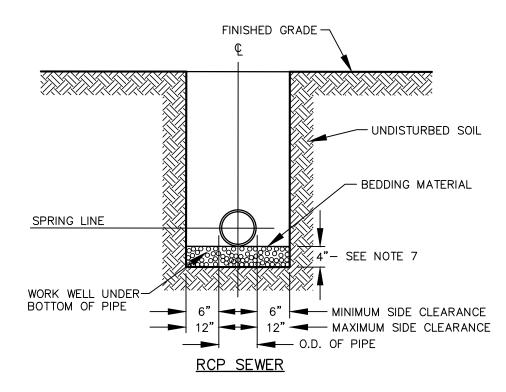


- WET OR UNSTABLE BOTTOMS, EXCAVATE MIN. 8" BELOW BELL. BACKFILL WITH WASHED CRUSHED STONE.
- 2. ROCK BOTTOMS, EXCAVTE MIN. 6" BELOW BELL. BACKFILL WITH WASHED CRUSHED STONE.
 3. FOR TRENCHES REQUIRING SHORING AND BRACING,
- DIMENSIONS SHALL BE TAKEN FROM THE INSIDE FACE
- OF THE SHORING AND BRACING. 4. NO ROCKS OR BOULDERS 6" OR LARGER TO BE USED IN BACKFILL. 5.
 ALL BACKFILL MATERIAL SHALL BE SUITABLE NATIVE MATERIAL
- 6. BACKFILL SHALL BE TAMPED IN 6" LAYERS.
- 7. WET OR UNSTABLE BOTTOMS, EXCAVATE MIN. 4" BELOW BELL. BACKFILL WITH WASHED CRUSHED STONE.

PIPE BEDDING DIMENSIONS FOR PVC, HDPE & RCP SEWER/DRAIN PIPE

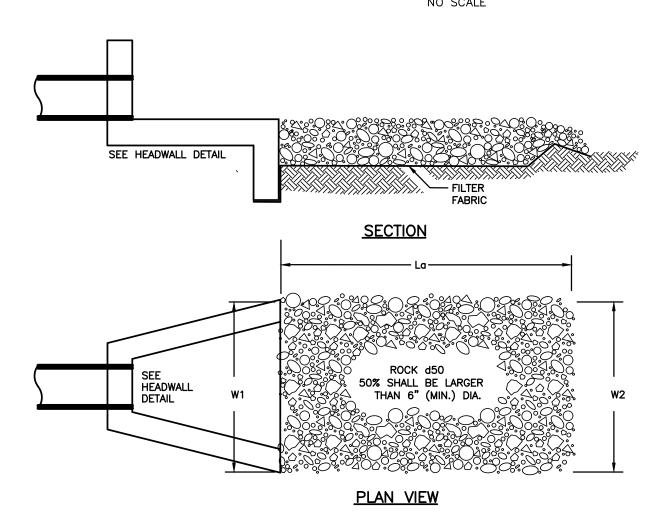

NOTES: 1. APRON SHALL BE SET AT A ZERO GRADE AND ALIGNED STRAIGHT. 2. FILTER MATERIAL SHALL BE FILTER FABRIC OR 6" THICK (MIN.) GRADED GRAVEL LAYER

ENERGY DISSIPATER AT HEADWALL

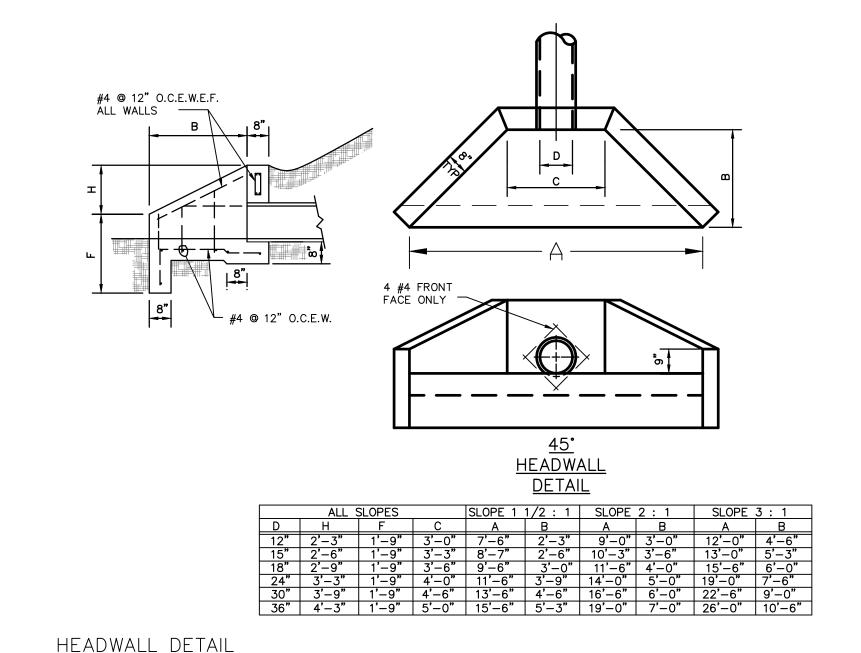

0 6 8 7 9 6 4 8 8 1

DESIGN

SITE

THE PARK AT HANAHAN


CITY OF HANAHAN BERKELEY COUNTY SOUTH CAROLINA


THE PARK AT HANAHAN, LP 3715 NORTHSIDE PKWY, NW BLDG 400, SUITE 120 ATLANTA, GA 30327


HORZ. SCALE: N/A N/A VERT. SCALE WTB DESIGNED BY. DRAWN BY WTB CSW CHECKED BY. 1/8/2021 S200437-DETAIL.dwg


> **STORMDRAIN DETAILS**

SHEET 7 OF XX

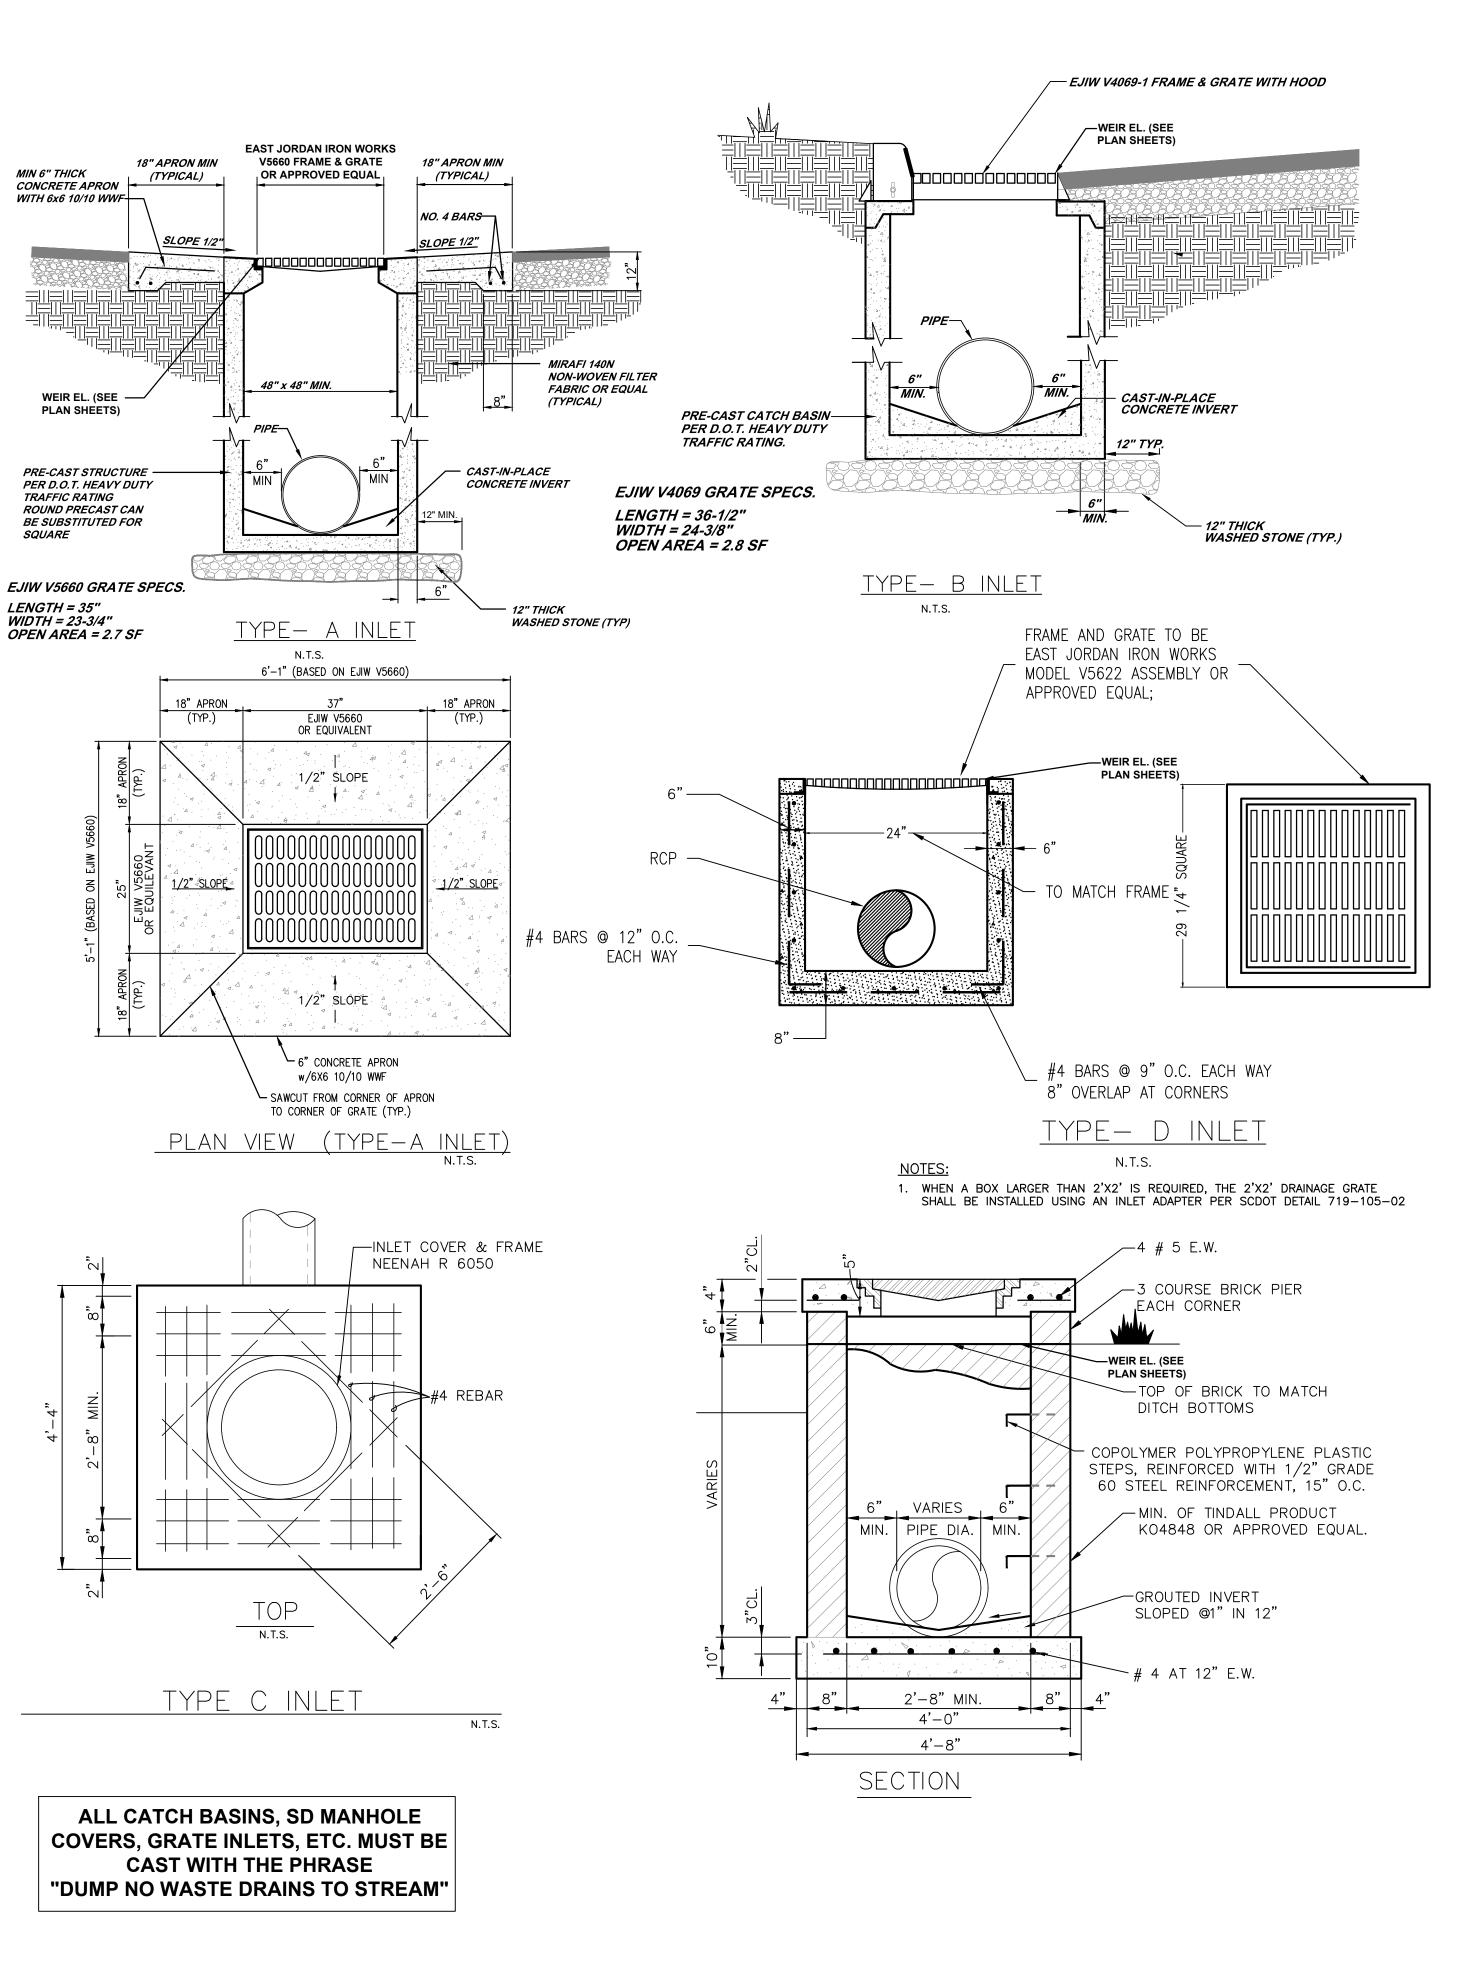

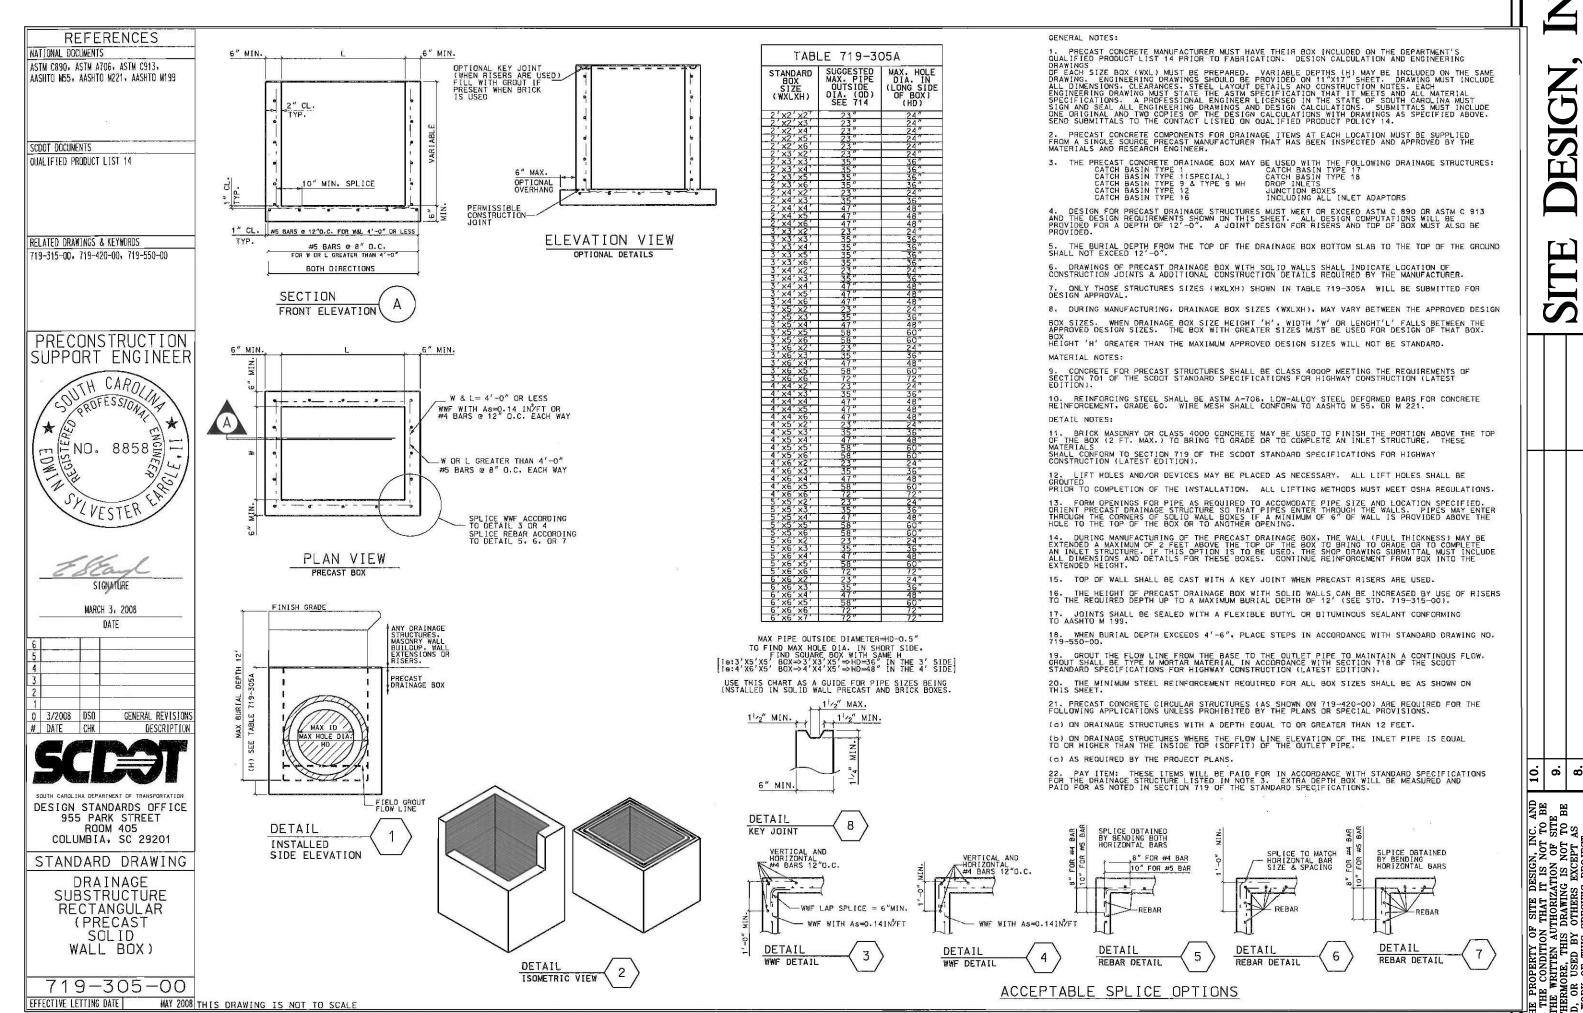

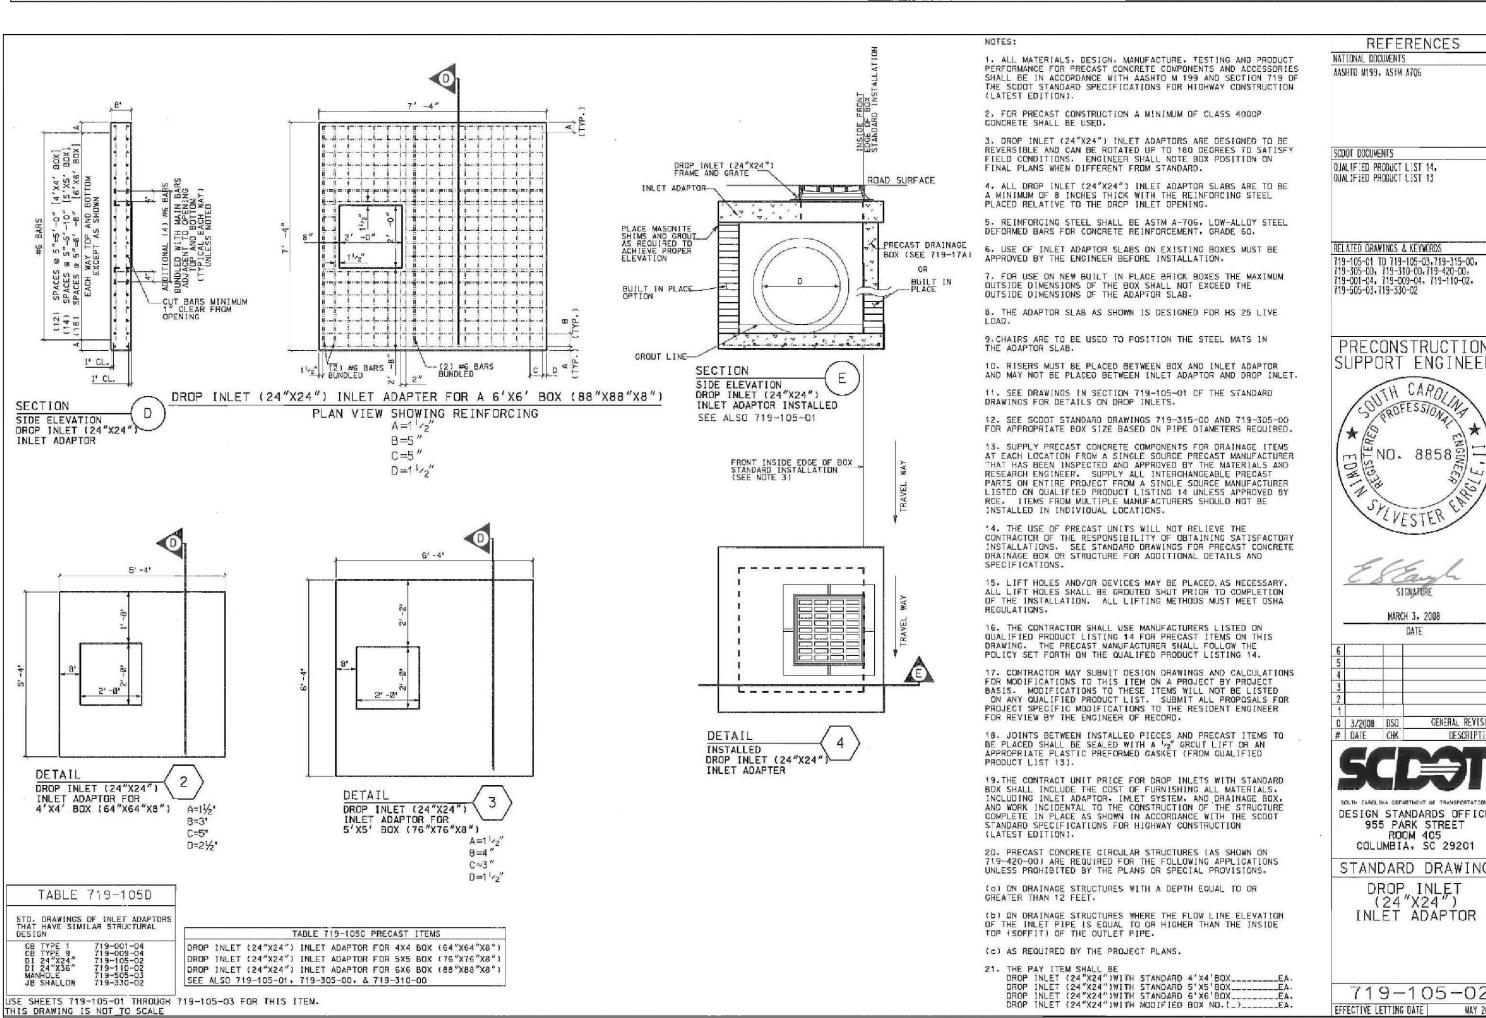

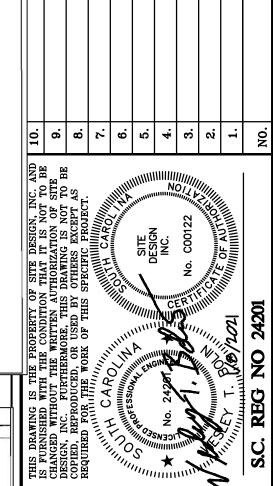

THE PARK AT **HANAHAN**

CITY OF HANAHAN BERKELEY COUNTY SOUTH CAROLINA

PRECONSTRUCTION SUPPORT ENGINEE SPOFESSION ¬严NO、8858到〒

ROOM 405

COLUMBIA. SC 29201

STANDARD DRAWIN

DROP, INLET

(24"X24") INLET ADAPTOR

719-105-02

REFERENCES


THE PARK AT HANAHAN, LP 3715 NORTHSIDE PKWY, NW **BLDG 400, SUITE 120** ATLANTA, GA 30327


HORZ. SCALE: N/A N/A VERT. SCALE: DESIGNED BY. WTB 0 3/2008 DSD GENERAL REVISION
DATE CHK DESCRIPTION WTB DRAWN BY CHECKED BY: CSW 1/8/2021 SOUTH CAROLINA DEPARTMENT OF TRANSPORTATION S200437-DETAIL.dwg DESIGN STANDARDS OFFIC 955 PARK STREET


STORMDRAIN

DETAILS

SHEET 8 OF XX

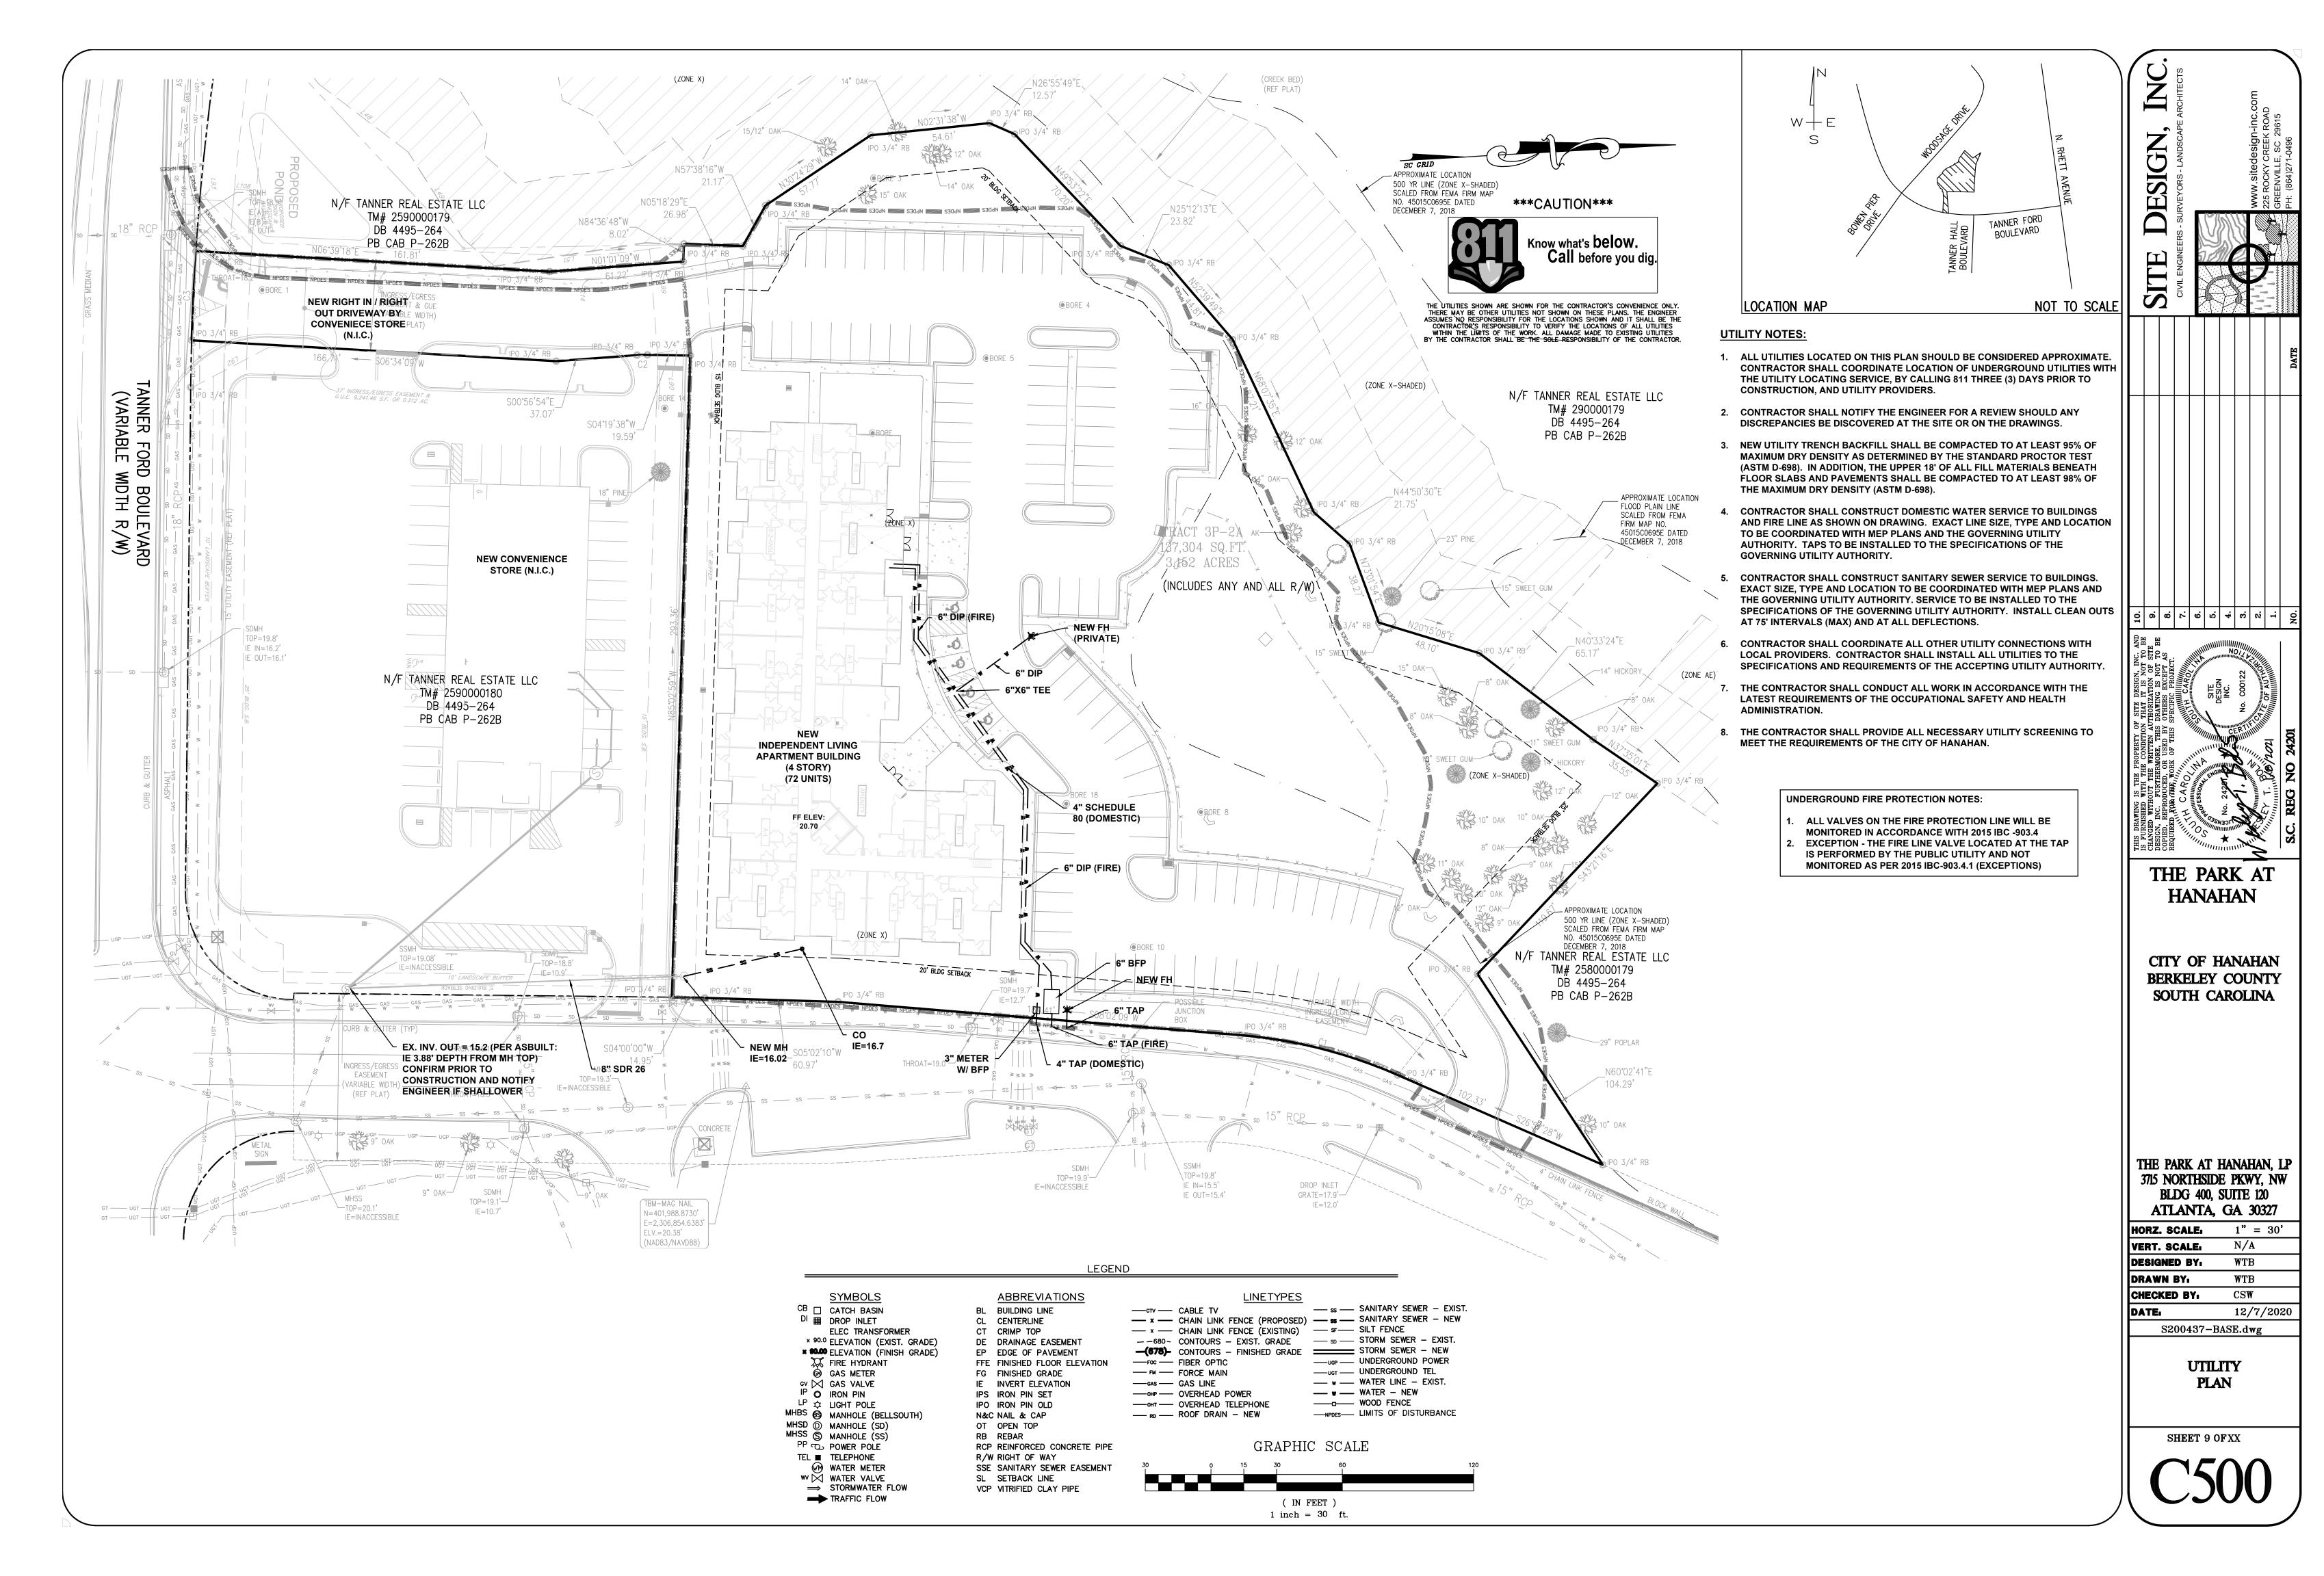


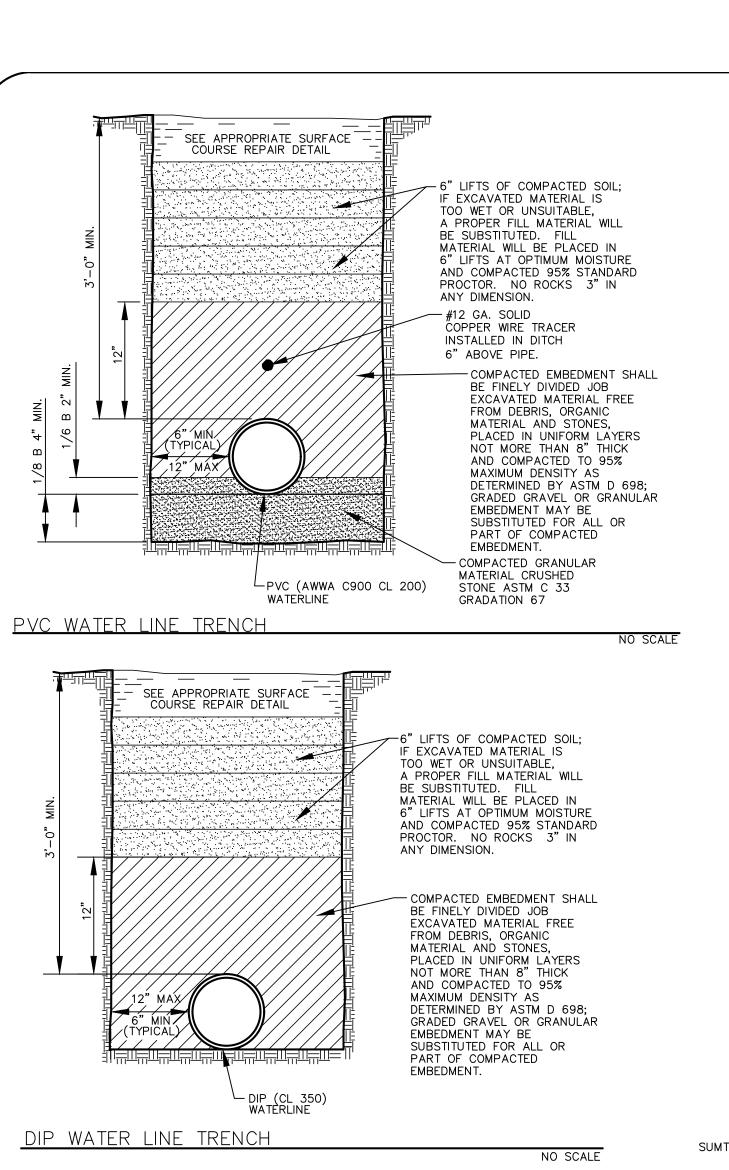


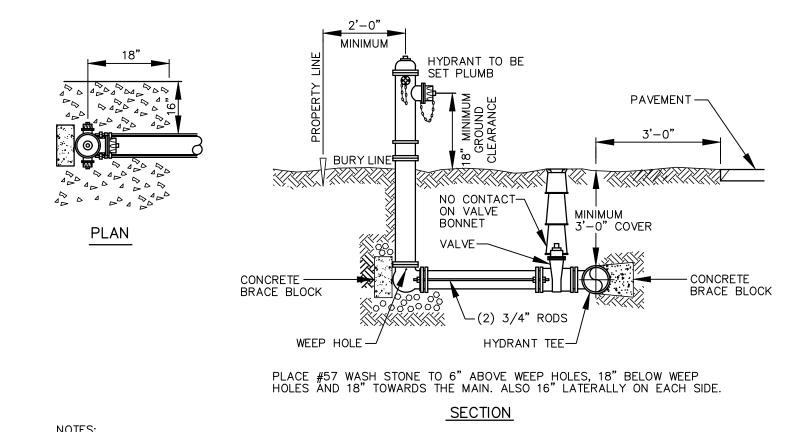


- I. RODS TO BE MADE OF STEEL HAVING A TENSILE STRENGTH OF 60,000 P.S.I.. RODS TO BE ZINC COATED. 2. AFTER INSTALLATION, ALL STEEL COMPONENTS, INCLUDING STRAPS, NUTS, BOLTS, COUPLINGS AND CLAMPS
- SHALL BE COATED WITH 17.5 MILS OF KOPPERS BITMASTIC 300-M OR EQUAL. 3. HYDRANT NOZZLES PER LOCAL FIRE DEPARTMENT SPECS.
- 4. HYDRANT LEAD TO BE DUCTILE IRON.

FIRE HYDRANT ASSEMBLY

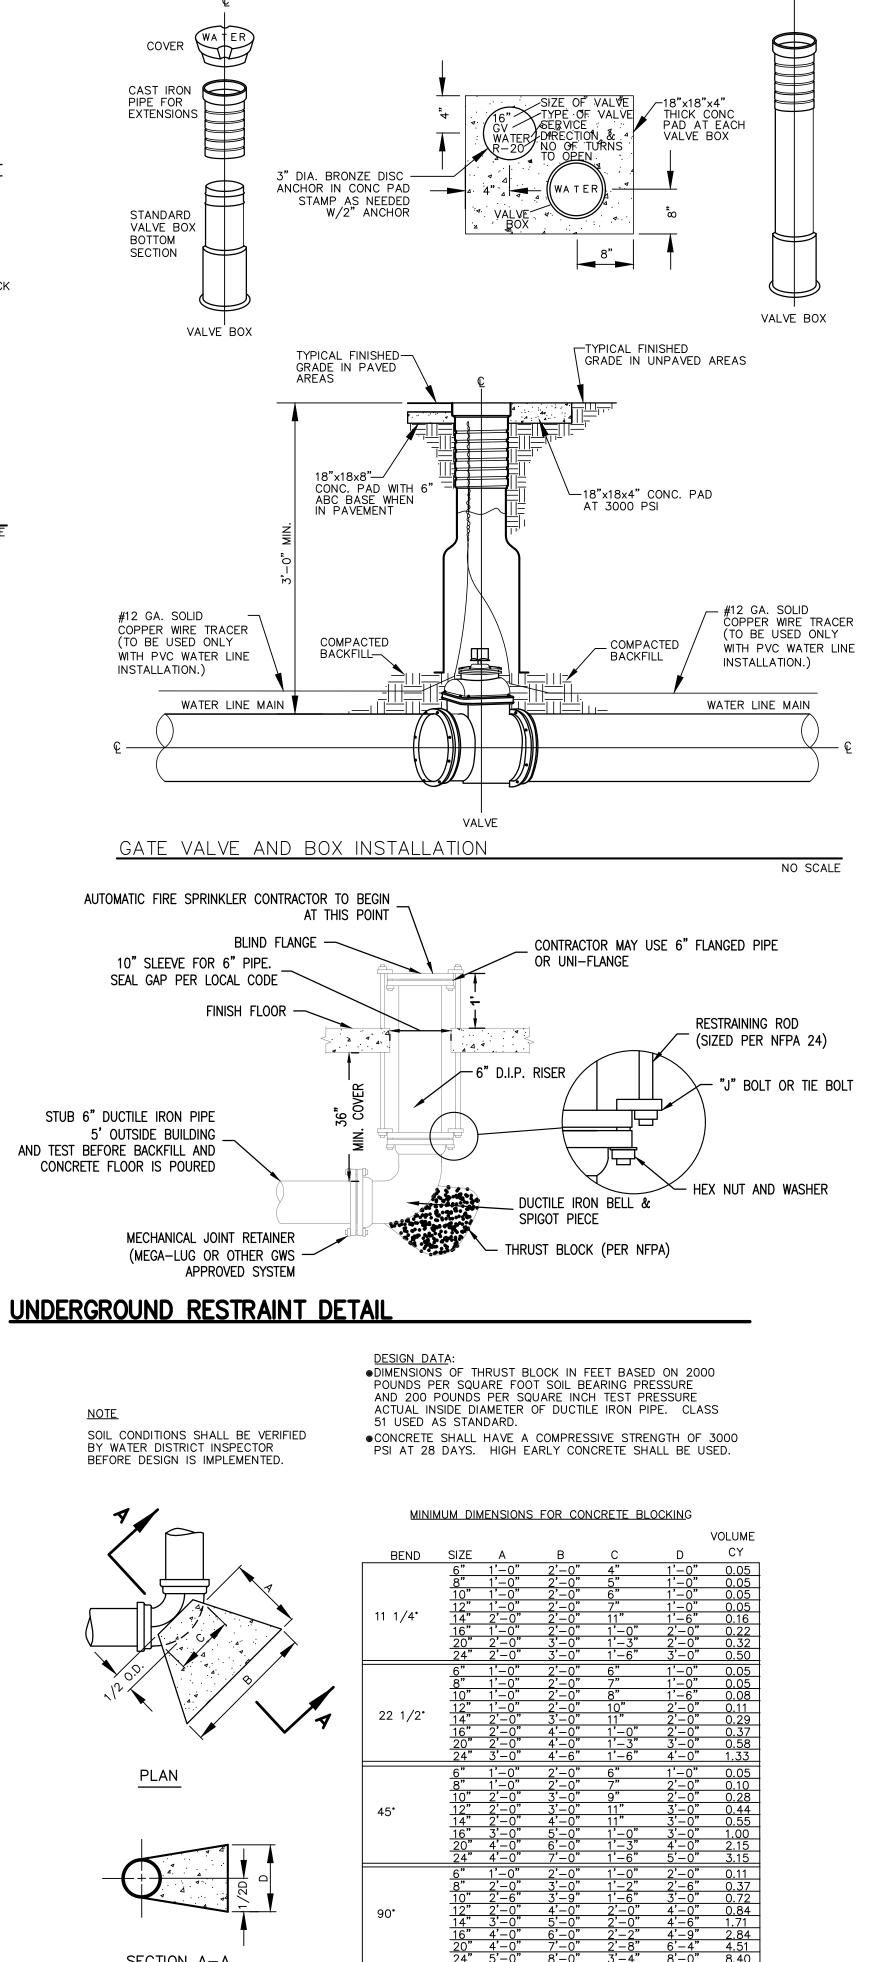

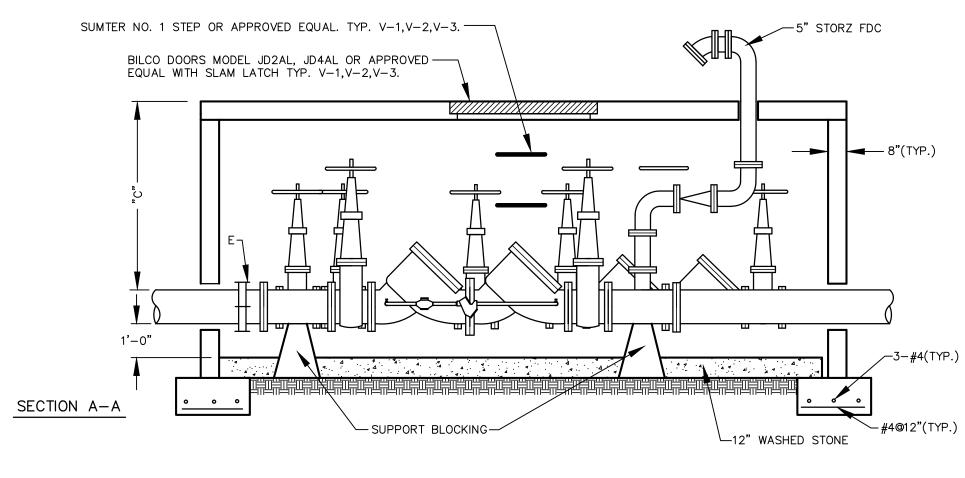

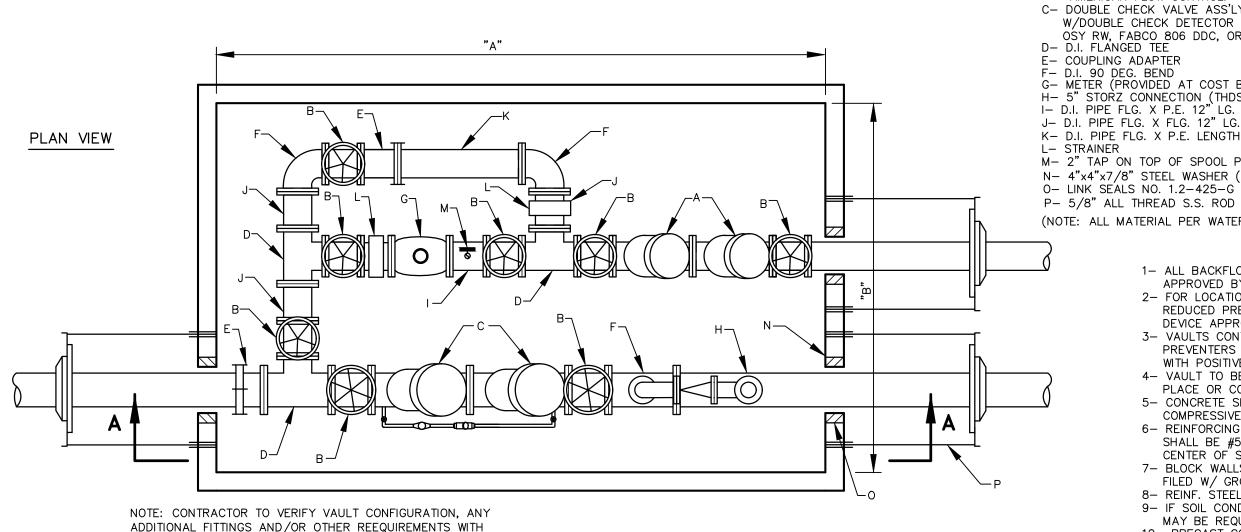

WITH LOCAL FIRE DEPARTMENT AND WATER SYSTEM.

BACKFLOW PREVENTER VAULT WITH FIRE AND POTABLE WATER LINES

LINE SIZE	А	В	С	DOOR SIZE	
2"	_	-	_	-	
3"	_	_	_	-	
4"	_	_	_	-	
6"	13'-0"	9'-0"	5'-0"	4' X 4' DBL. DR.	
8"	13'-0"	9'-0"	5'-0"	4' X 4' "	
10"	16'-6"	10'-0"	6'-0"	5' X 5' " (JD4AL)	
12"	16'-6"	10'-0"	6'-0"	5' X 5' " (JD4AL)	
MINIMUM INSIDE DIMENSION					

LEGEND

A- DOUBLE CHECK VALVE ASS'LY AS APPROVED BY S.C.D.H.E.C. B- O S & Y RESILIENT WEDGE VALVE FLG. X FLG. WITH HANDWHEEL OPERATOR AS MANUFACTURED BY MUELLER, U.S. PIPE & AMERICAN FLOW CONTROL.

C- DOUBLE CHECK VALVE ASS'LY AS APPROVED BY S.C.D.H.E.C. W/DOUBLE CHECK DETECTOR ASS'LY(E.G. WATTS 709 DC DA OSY RW, FABCO 806 DDC, OR EQUAL).

F- D.I. 90 DEG. BEND
G- METER (PROVIDED AT COST BY WATER DISTRICT) 3" METER
H- 5" STORZ CONNECTION (THDS. TO MATCH FIRE DEPT. REQ'TS.)
I- D.I. PIPE FLG. X P.E. 12" LG.
J- D.I. PIPE FLG. X FLG. 12" LG.

K- D.I. PIPE FLG. X P.E. LENGTH AS REQ'D. L- STRAINER M- 2" TAP ON TOP OF SPOOL PIECE WITH 3" NIPPLE & 2" VALVE N- 4"x4"x7/8" STEEL WASHER (COAT W/ COAL TAR EPOXY) 0- LINK SEALS NO. 1.2-425-G

(NOTE: ALL MATERIAL PER WATER DISTRICT SPECS)

1- ALL BACKFLOW PREVENTION DEVICES SHALL BE APPROVED BY S.C.D.H.E.C..

2- FOR LOCATIONS CONSIDERED HIGH HAZARD, A REDUCED PRESSURE TYPE BACKFLOW PREVENTION DEVICE APPROVED BY S.C.D.H.E.C. SHALL BE USED. 3- VAULTS CONTAINING REDUCED PRESSURE BACKFLOW

PREVENTERS SHALL HAVE A CONCRETE FLOOR WITH POSITIVE DRAIN OR SUMP PUMP. 4- VAULT TO BE PRECAST CONCRETE POURED IN PLACE OR CONCRETE BLOCK.

COMPRESSIVE STRENGTH, MINIMUM. 6- REINFORCING STEEL IN TOP SLAB & WALLS SHALL BE #5 REBAR @ 12" O.C. EA. DIRECTION IN CENTER OF SLAB & WALLS.

7- BLOCK WALLS SHALL BE 8" C.M.U. WITH CELLS FILED W/ GROUT. USE #5 REBAR @ 16" O.C.. 8- REINF. STEEL SHALL BE GRADE 60 STEEL. 9- IF SOIL CONDITIONS DICTATE, DRAIN SYSTEM

MAY BE REQUIRED. 10- PRECAST CONCRETE VAULT SIMILAR TO TINDALL CONCRETE VAULT MAY BE SUBSTITUTED UPON APPROVAL.

5- CONCRETE SHALL BE 3000 PSI, 28 DAY

SECTION A-A

TEES PLUGS

NO SCALE

CONCRETE THRUST BLOCK

SHEET100F XX

DESIGN

SITE

THE PARK AT

HANAHAN

CITY OF HANAHAN BERKELEY COUNTY SOUTH CAROLINA

THE PARK AT HANAHAN, LP

3715 NORTHSIDE PKWY, NW

BLDG 400, SUITE 120

ATLANTA, GA 30327

S200437-DETAIL.dwg

WATER

DETAILS

N/A

N/A

WTB

WTB

CSW

1/8/2021


HORZ. SCALE:

VERT. SCALE:


DESIGNED BY.

DRAWN BY


CHECKED BY:

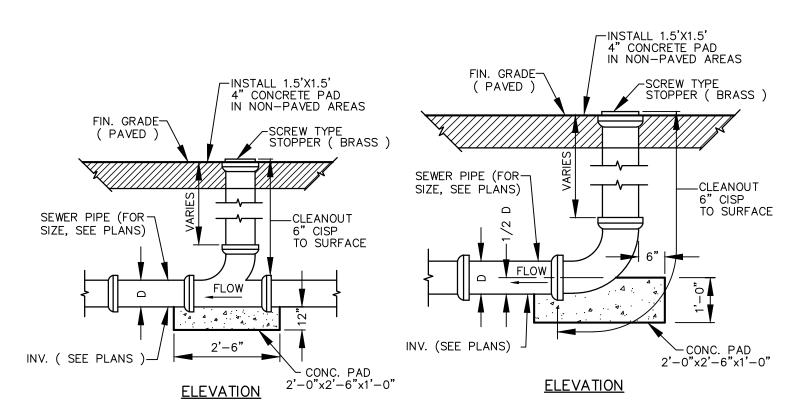

END OF LINE CLEANOUT IN LINE CLEANOUT

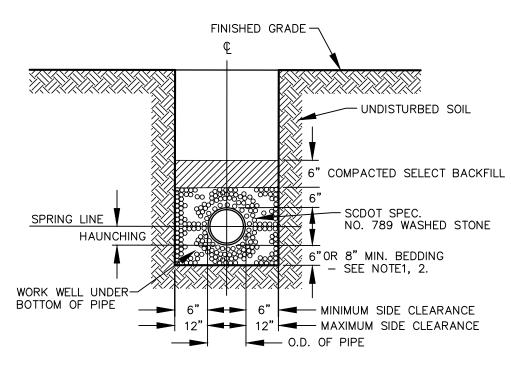



PVC & HDPE SEWER

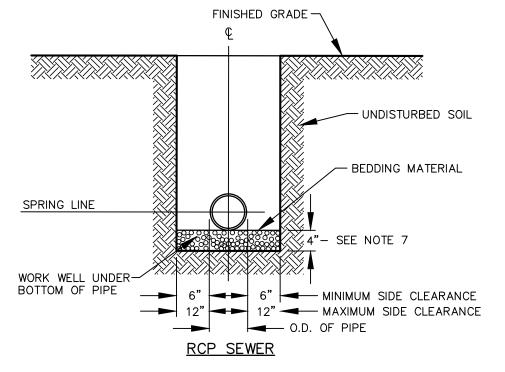

NOTES:

- 1. WET OR UNSTABLE BOTTOMS, EXCAVATE MIN. 8" BELOW BELL.
- BACKFILL WITH WASHED CRUSHED STONE. 2. ROCK BOTTOMS, EXCAVTE MIN. 6" BELOW BELL. BACKFILL WITH WASHED CRUSHED STONE.
- 3. FOR TRENCHES REQUIRING SHORING AND BRACING,
 DIMENSIONS SHALL BE TAKEN FROM THE INSIDE FACE
- OF THE SHORING AND BRACING. 4. NO ROCKS OR BOULDERS 6" OR LARGER TO BE USED IN BACKFILL. 5. ALL BACKFILL MATERIAL SHALL BE SUITABLE NATIVE MATERIAL
- EXCEPT AS NOTED.
- 6. BACKFILL SHALL BE TAMPED IN 6" LAYERS. 7. WET OR UNSTABLE BOTTOMS, EXCAVATE MIN. 4" BELOW BELL.
- BACKFILL WITH WASHED CRUSHED STONE.

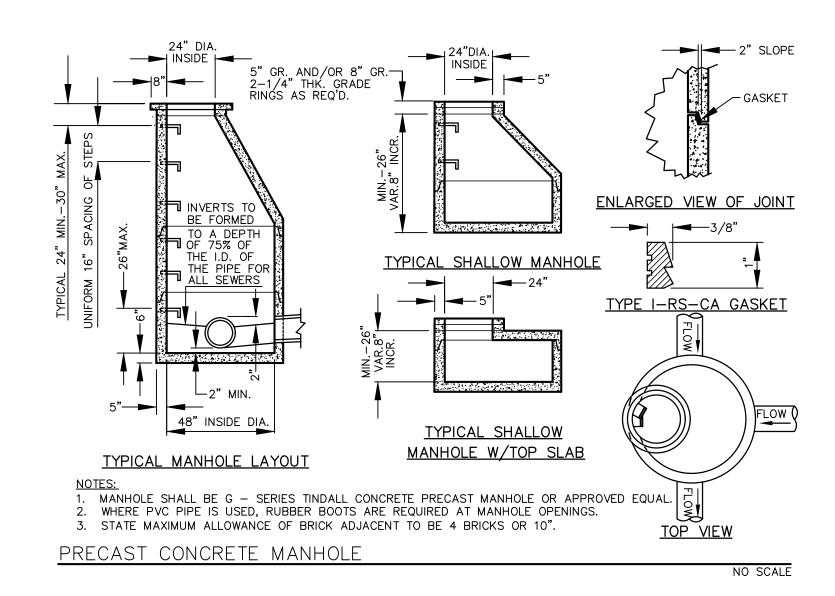

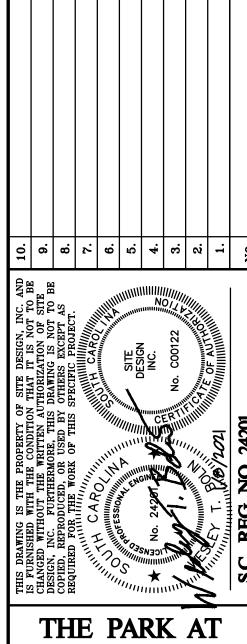

DESIGN

SITE

HANAHAN

CITY OF HANAHAN BERKELEY COUNTY SOUTH CAROLINA


THE PARK AT HANAHAN, LP 3715 NORTHSIDE PKWY, NW BLDG 400, SUITE 120 ATLANTA, GA 30327


HORZ. SCALE:	N/A			
VERT. SCALE:	N/A			
DESIGNED BY:	WTB			
DRAWN BY:	WTB			
CHECKED BY.	CSW			
DATE:	1/8/2021			
S200437-DETAIL.dwg				


SANITARY SEWER **DETAILS**

SHEET110F XX

PIPE BEDDING DIMENSIONS FOR PVC, HDPE & RCP SEWER/DRAIN PIPE

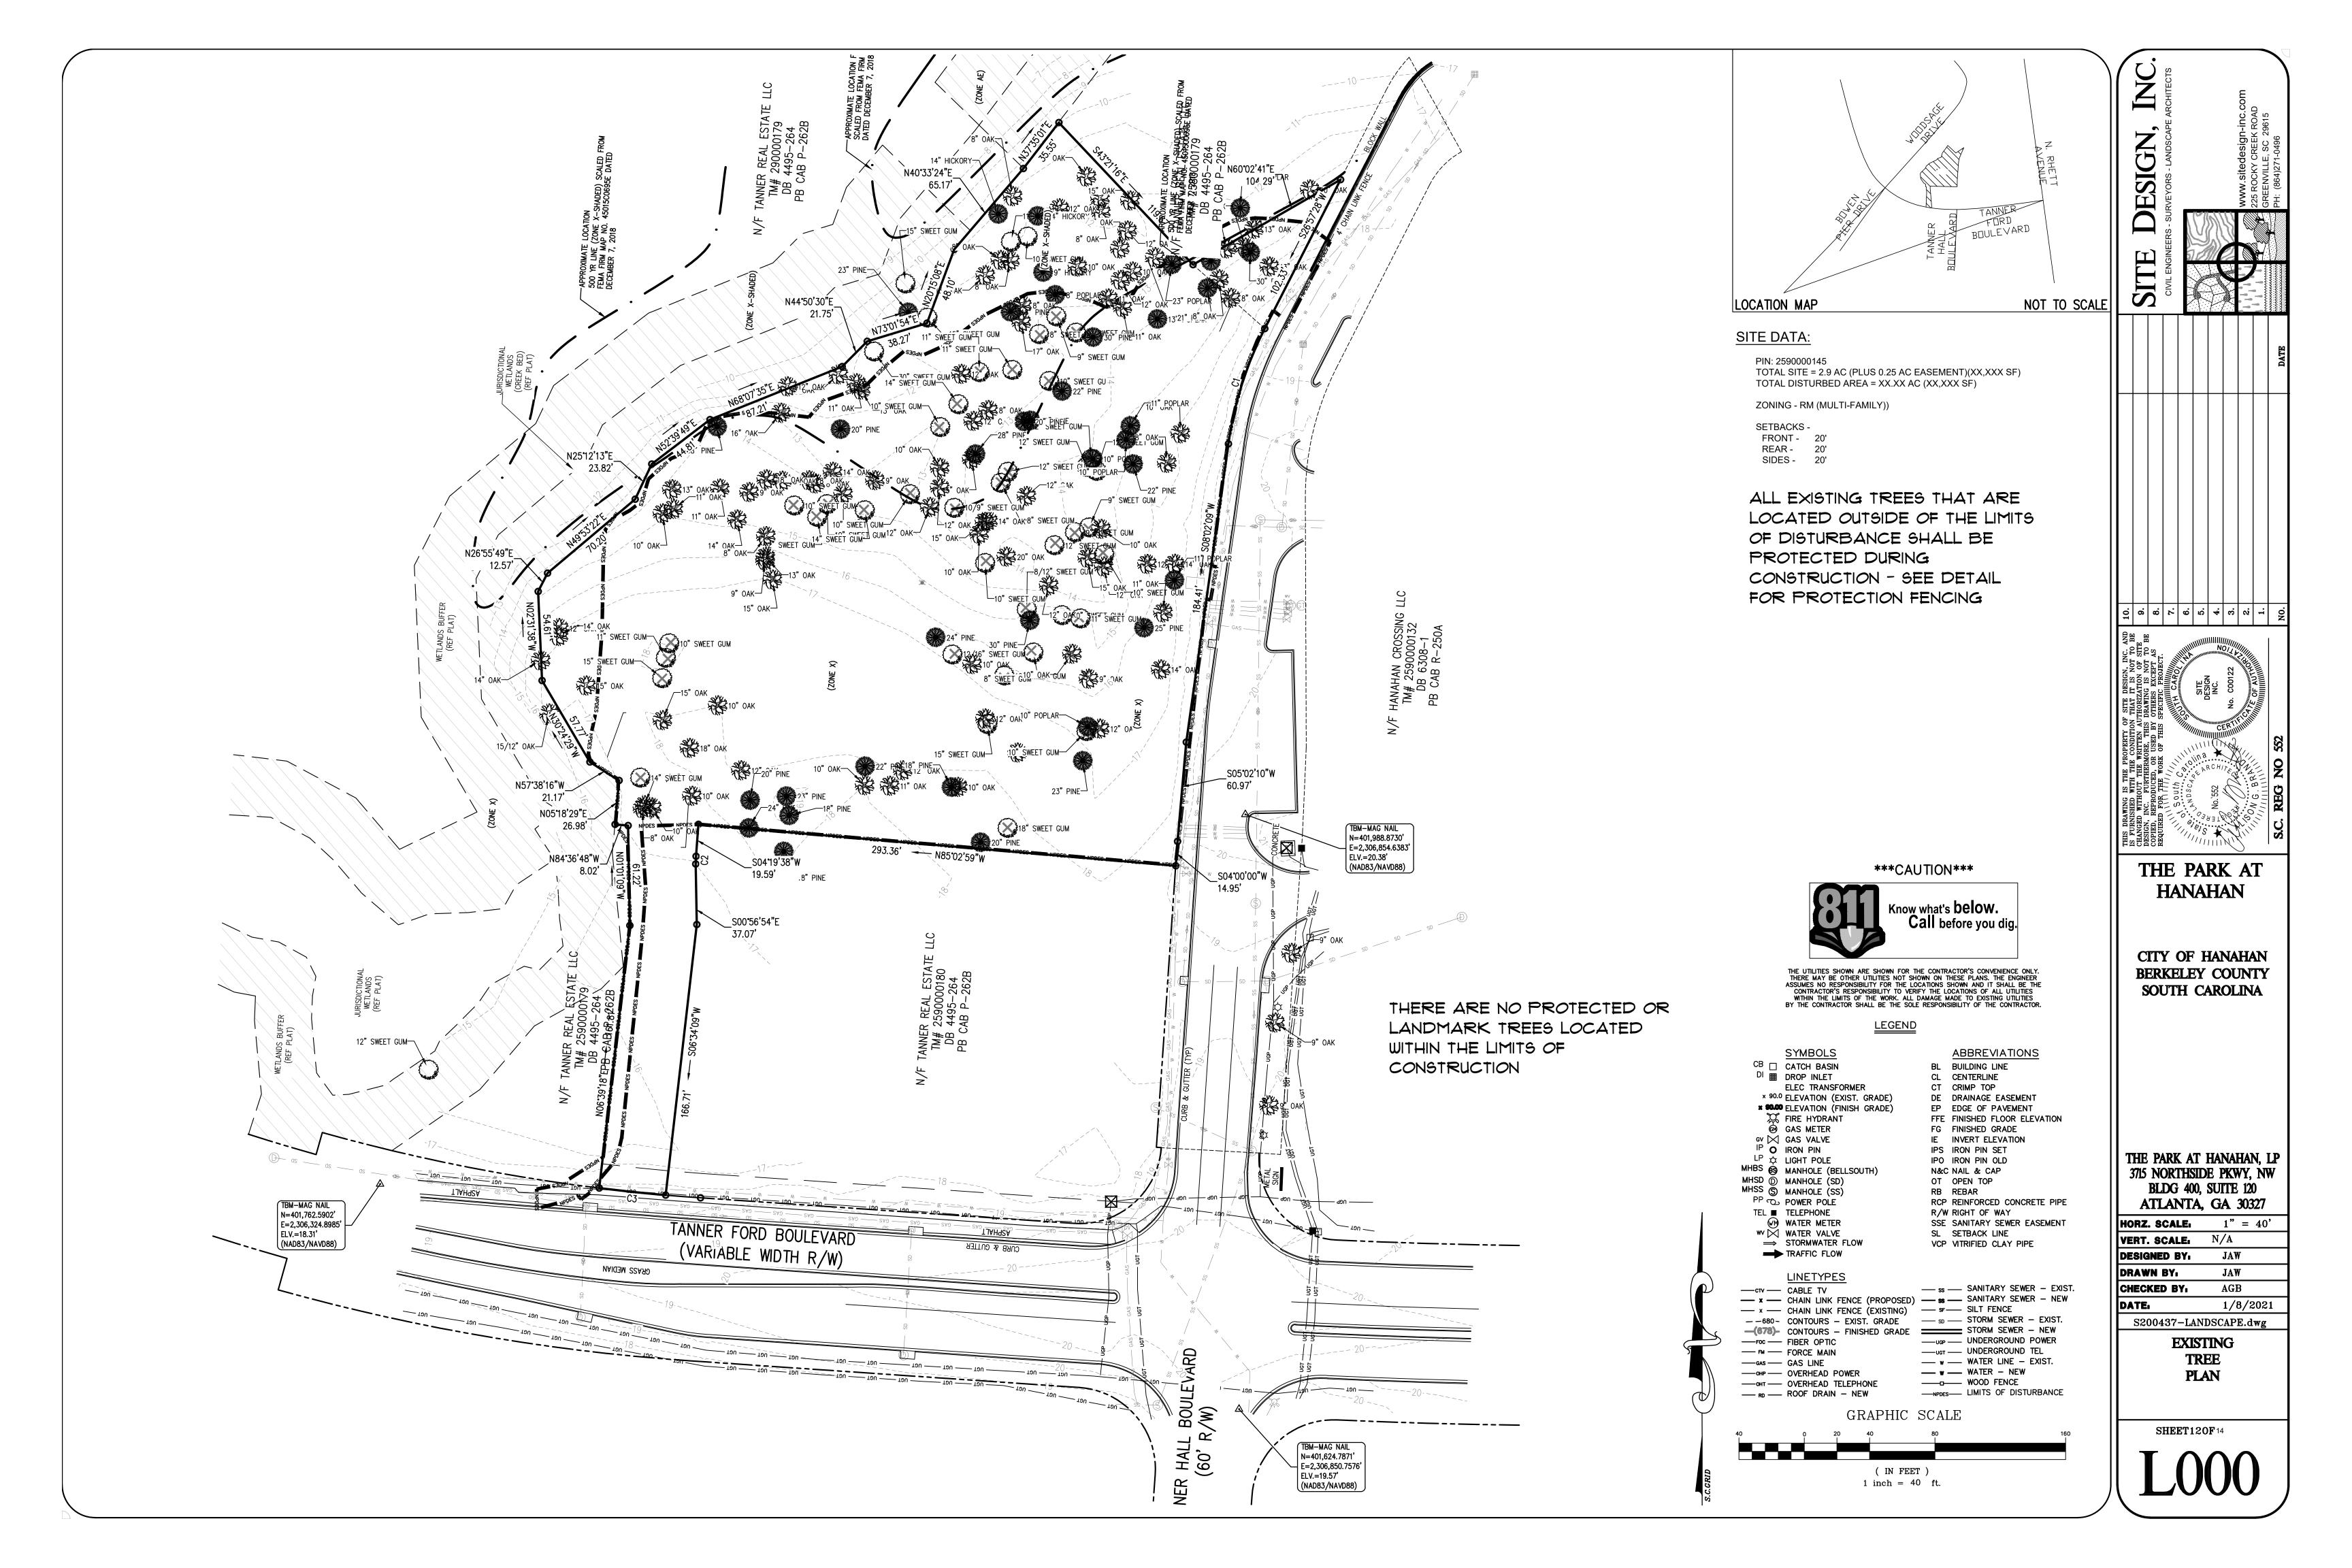

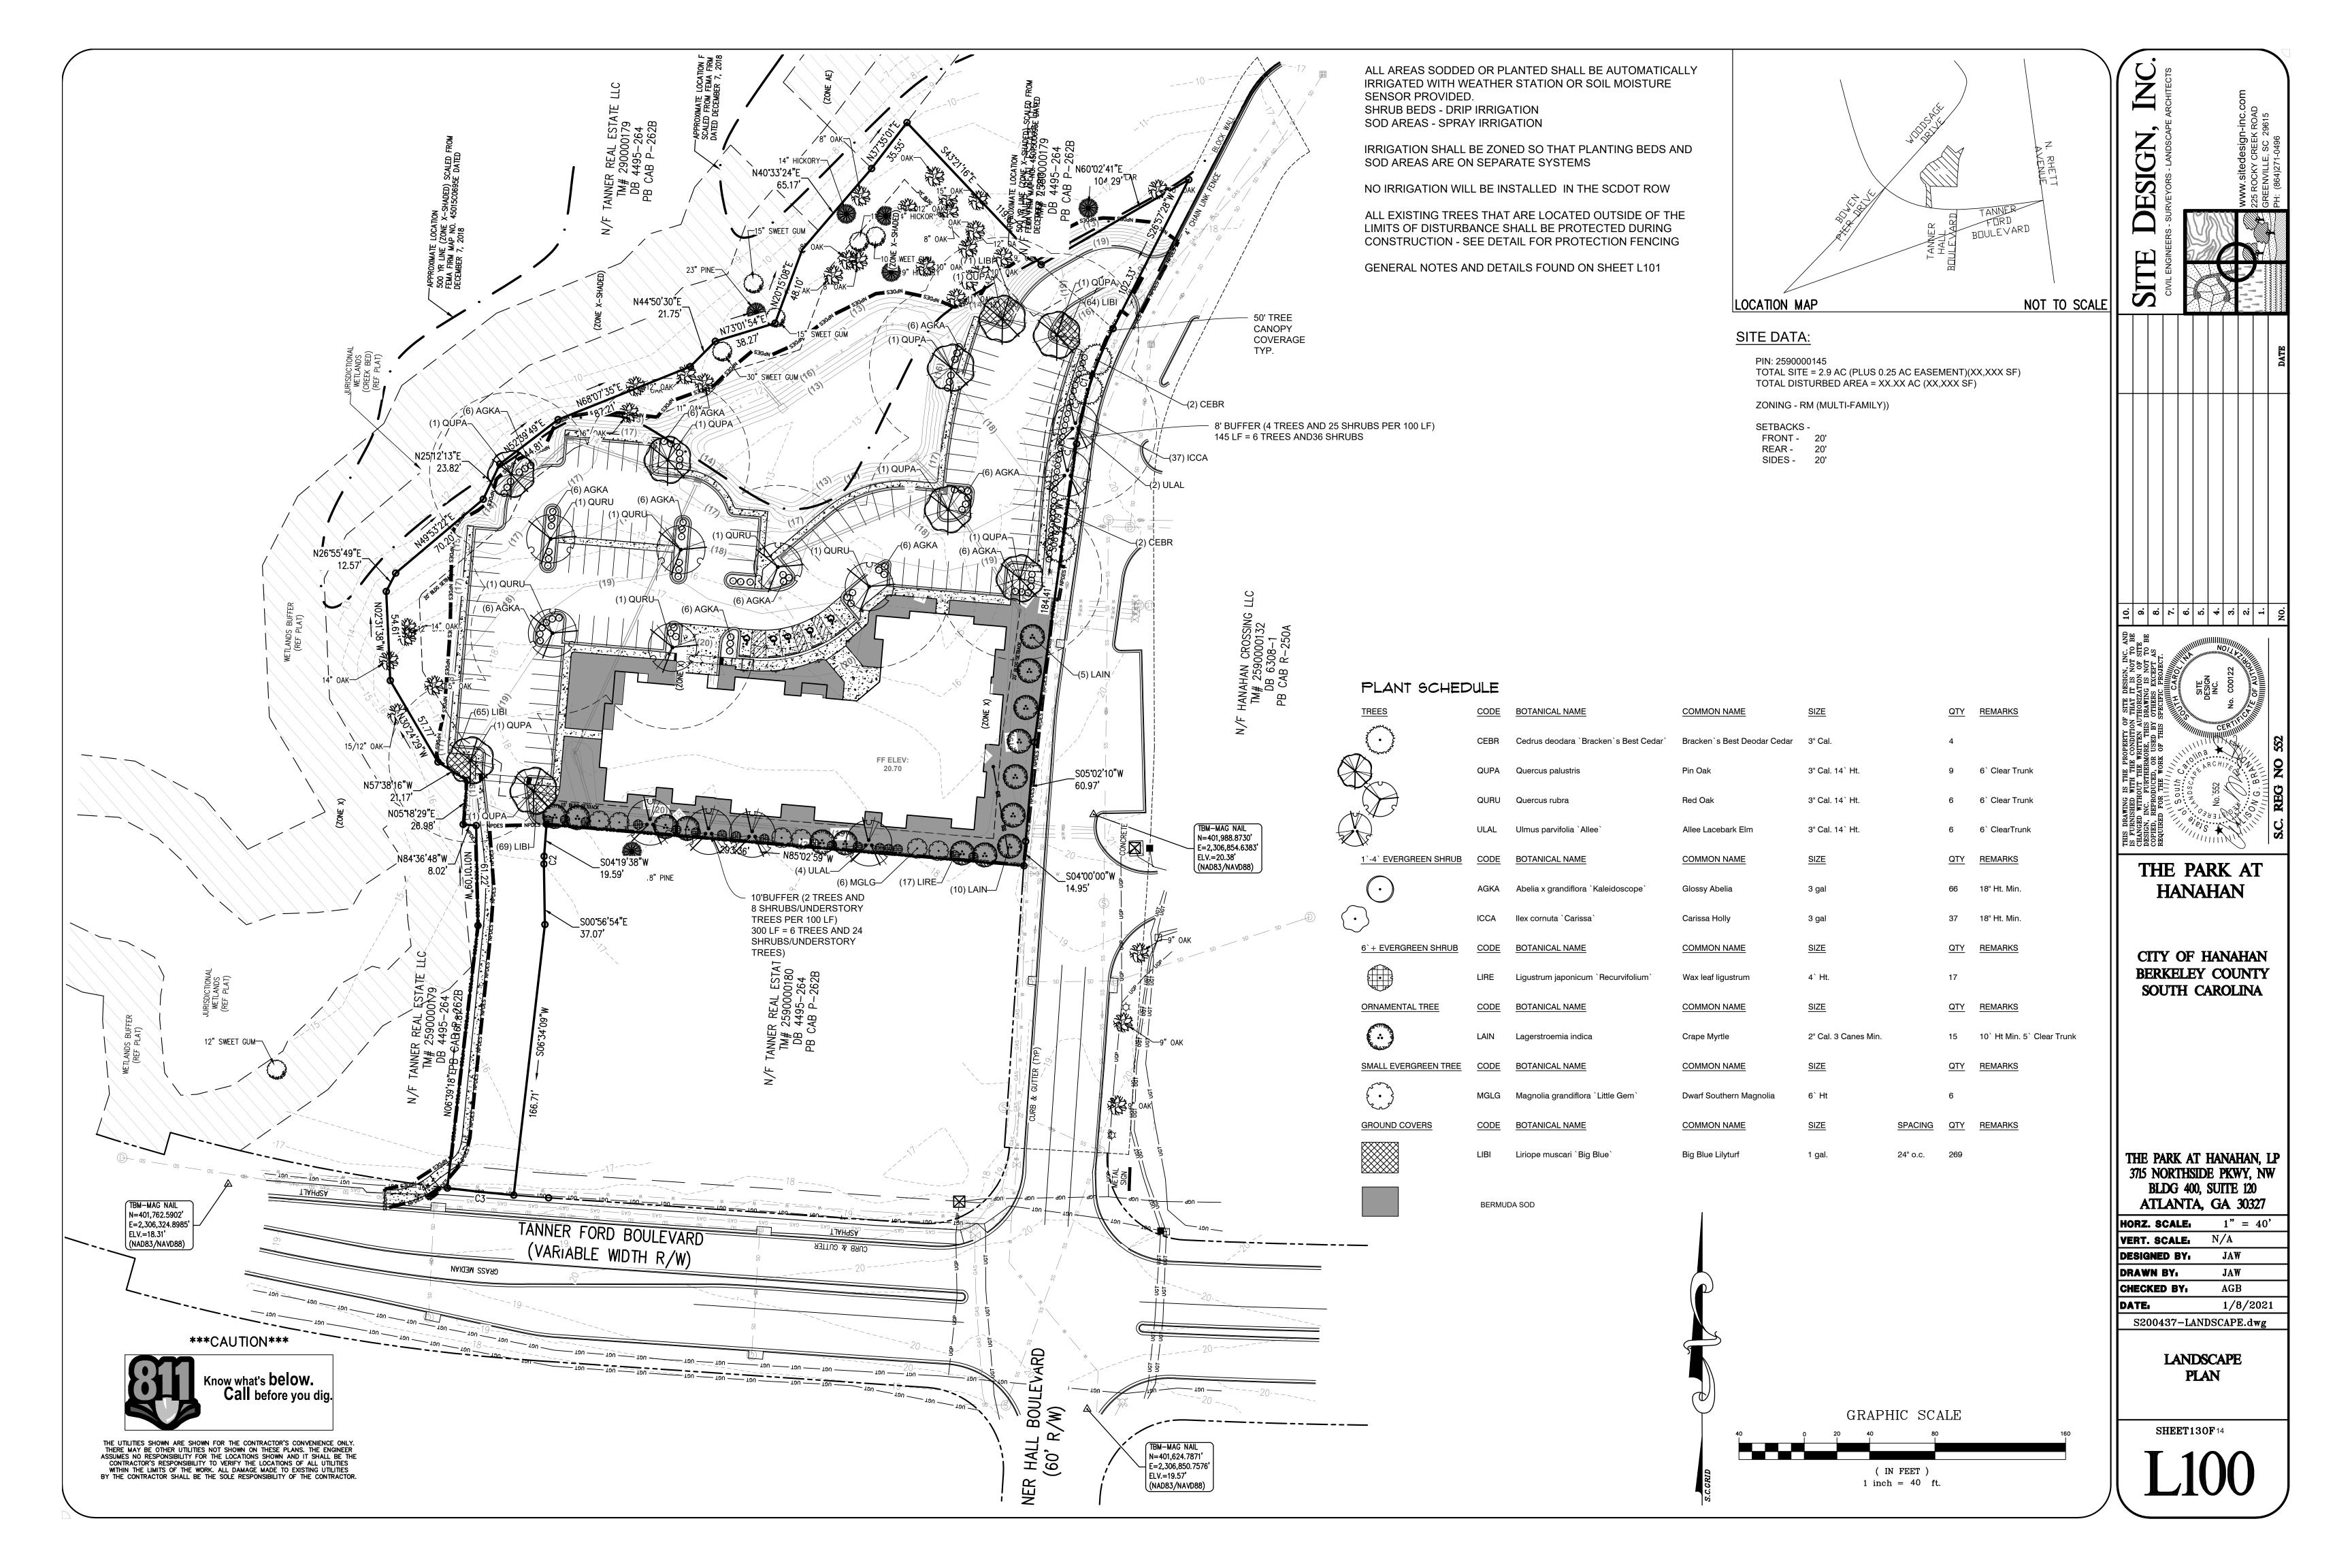


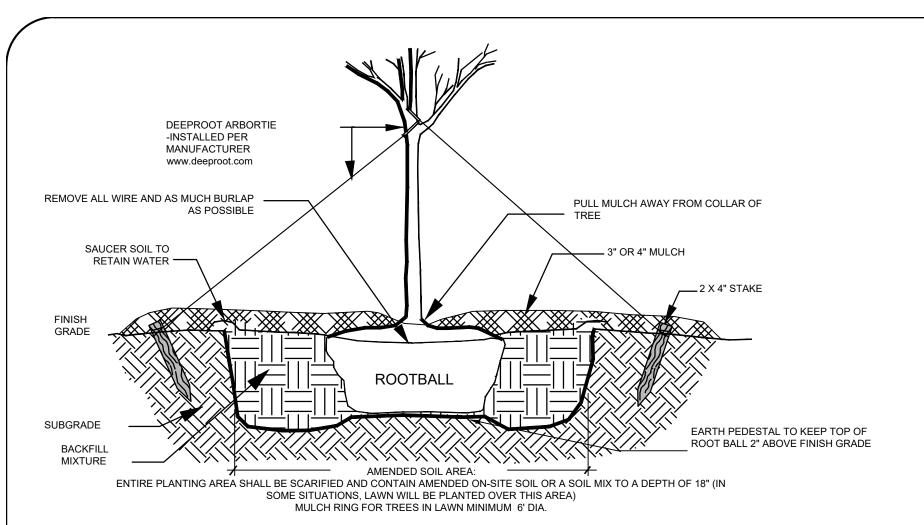

1. REMOVE WIRE OR NYLON TWINE FROM ROOT BALL

2. INSTALL TOP OF BALL 2" ABOVE FINISH GRADE 3. SOAK ROOT BALL AND PLANT PIT IMMEDIATELY AFTER INSTALLATION 4. 4" SAUCER WILL BE OUTSIDE OF BACKFILL.

REE OVER 2" CAL. WITH STAKING

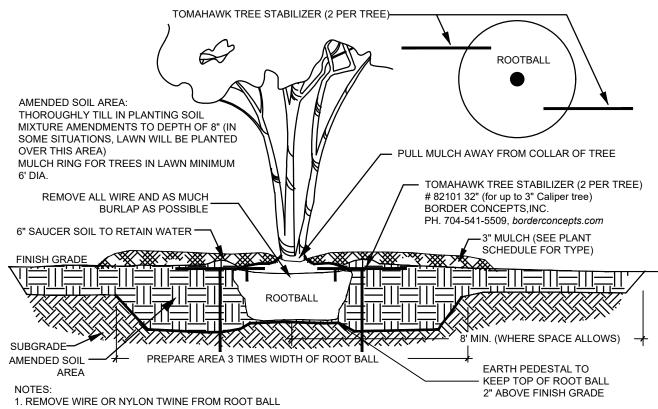

2. INSTALL TOP OF ROOT BALL 2" ABOVE FINISH GRADE

- 3 SCARIFY SIDES AND BOTTOM OF PIT 4. BACKFILL TREE PIT WITH SPECIFIED PLANTING SOIL MIXTURE IN 8" LAYERS, HAND TAMP TO REMOVE VOIDS.
- 5 WHEN % BACKEILLED FILL WITH WATER 6. AFTER BACKFILLING AND TAMPING FINAL LAYER, WATER AGAIN UNTIL NO MORE IS ABSORBED
- 7. 6" SAUCER WILL BE INSIDE OF BACKFILL. 8. DO NOT WRAP TREE TRUNK.

MULTI-TRUNK TREE

ALL AREAS SODDED OR PLANTED SHALL BE AUTOMATICALLY IRRIGATED WITH WEATHER STATION OR SOIL MOISTURE SENSOR PROVIDED. SHRUB BEDS - DRIP IRRIGATION SOD AREAS - SPRAY IRRIGATION

IRRIGATION SHALL BE ZONED SO THAT PLANTING BEDS AND SOD AREAS ARE ON SEPARATE SYSTEMS

NO IRRIGATION WILL BE INSTALLED IN THE SCDOT ROW

ALL EXISTING TREES THAT ARE LOCATED OUTSIDE OF THE LIMITS OF DISTURBANCE SHALL BE PROTECTED DURING CONSTRUCTION - SEE DETAIL FOR PROTECTION FENCING

SITE DATA:


PIN: 2590000145 TOTAL SITE = 2.9 AC (PLUS 0.25 AC EASEMENT)(XX,XXX SF) TOTAL DISTURBED AREA = XX.XX AC (XX,XXX SF)

ZONING - RM (MULTI-FAMILY))

SETBACKS -FRONT - 20' REAR -SIDES - 20'




THE UTILITIES SHOWN ARE SHOWN FOR THE CONTRACTOR'S CONVENIENCE ONLY THERE MAY BE OTHER UTILITIES NOT SHOWN ON THESE PLANS. THE ENGINEER ASSUMES NO RESPONSIBILITY FOR THE LOCATIONS SHOWN AND IT SHALL BE THE CONTRACTOR'S RESPONSIBILITY TO VERIFY THE LOCATIONS OF ALL UTILITIES WITHIN THE LIMITS OF THE WORK. ALL DAMAGE MADE TO EXISTING UTILITIES BY THE CONTRACTOR SHALL BE THE SOLE RESPONSIBILITY OF THE CONTRACTOR.

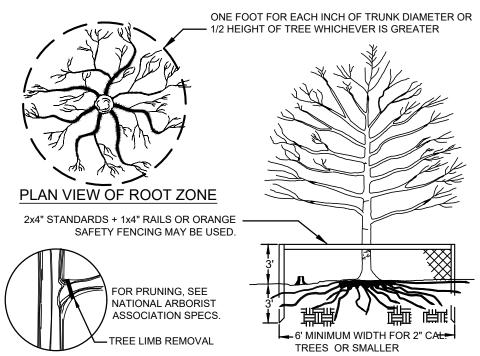

1, NO CONSTRUCTION ACTIVITY OR STORAGE SHALL BE LOCATED WITHIN THE PROTECTION AREA. 2. REMOVE ALL BARRIERS UPON COMPLETION OF PROJECT. 3. SEE PLANS FOR LOCATION AND REQUIRED RADIUS OF ALL TREE PROTECTION FENCES. 4. DEAD TREES AND SCRUB OR UNDER GROWTH SHALL BE CUT FLUSH WITH ADJACENT GRADE. NO GRUBBING ALLOWED LINDER DRIPLINE 5. PLACE 4" LAYER OF MULCH AT AREAS NOT PROTECTED BY BARRIER. 6. CONTRACTOR SHALL MAINTAIN TREE PROTECTION FENCE UNTIL FINAL CERTIFICATE OF OCCUPANCY. IF THE T.P. FENCE IS DAMAGED DURING CONSTRUCTION, IT WILL BE CONTRACTOR'S RESPONSIBILITY TO REPAIR <u>AND</u> NOTIFY L.A OF ANY POSSIBLE DAMAGE TO TREES.




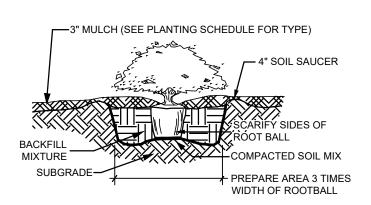

1. REMOVE WIRE, NYLON TWINE OR CONTAINER FROM ROOT BALL. 2. SCARIFY SIDES AND BOTTOM OF HOLE AS WELL AS THE ROOT BALL. 3. INSTALL TOP OF BALL 2" ABOVE FINISH GRADE 4. ROOT BALLS GREATER THAN 2' IN DIAMETER SHALL SIT ON MOUND OF UNDISTURBED SOIL TO PREVENT SETTLING. 5. ROOT BALLS SMALLER THAN 2' MAY SIT ON COMPACTED SOIL MIXTURE. 6. BACKFILL PIT WITH SPECIFIED PLANTING SOIL MIXTURE IN 8" LAYERS, HAND TAMP TO REMOVE VOIDS.

7. WHEN 3/ BACKFILLED. FILL WITH WATER 8. AFTER BACKFILLING AND TAMPING FINAL LAYER, WATER AGAIN UNTIL NO MORE IS 9. 4" SAUCER WILL BE OUTSIDE OF BACKFILL.



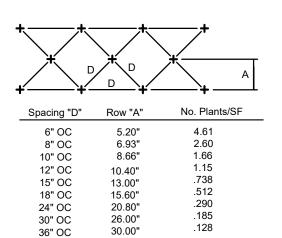

1. THOROUGHLY TILL IN PLANTING SOIL MIXTURE AMENDMENTS TO DEPTH OF 8" IN ENTIRE PLANTING BED. 2. WORK SOIL TO LOOSE UNIFORM FINE TEXTURE. 3. HAND TAMP TO REMOVE VOIDS AND AIR POCKETS. 4. WATER THOROUGHLY AFTER PLANTING UNTIL NO MORE WATER IA ABSORBED.

SHRUB OR GROUNDCOVER SPACING
N.T.S.

GENERAL NOTES & SPECIFICATIONS

LAWN INSTALLATION: Lawn areas shall be fine graded to a smooth, positively draining slope, removing all stones over 3/4". Agricultural limestone shall be incorporated into the soil at a rate of 50 pounds per 1000 square feet. Apply specified seed at recommended rate. Straw mulch or hydromulch shall be used as deemed necessary by the Landscape Contractor and Landscape Architect. The Landscape Contractor shall be responsible to establish a full stand of grass and will repair any bare spots 1'- 0" square due to uneven seed distribution, drought or erosion

SOD INSTALLATION: Sodded lawn areas shall be fine graded to a smooth, positively draining slope, removing all stones over 3/4". Sod shall be healthy, thick sod placed so that joints are butt tight. Staple as necessary. Sod shall be trimmed to match bed lines shown on plan. Startup fertilizer shall be incorporated into the soil at the manufacturer's recommended rate. Any area of sod that fails to root, settles or dies will be replace by the Landscape

UTILITY LOCATION: The Landscape Contractor is responsible for contacting the utility locator service and is responsible for any damage done to utilities.

QUANTITIES Plant quantities are shown for the contractor's convenience only. PLANTS SHALL BE INSTALLED AS SHOWN. Contractor is responsible for confirming all quantities prior to bidding and installation.

BIDS In order to keep all bids standard, all bids are to have unit prices listed. The Owner has the option to delete any portion of the contract prior to signing the contract or beginning work. This will be a unit price contract.

PLANT QUALITY All plants shall be nursery grown, have a full habit of growth as is characteristic of that species, and shall be free of disease or insects. General plant quality shall be as specified in the "USA Standard for Nursery Stock" (published by the American Association of Nurserymen). Please contact the Landscape Architect if there is difficulty in locating a particular plant. If necessary, a substitute plant will be recommended by the Landscape

PLANTING AREA PREPARATION: Entire planting area shall be scarified and contain amended on-site soil or a soil mix to a depth of no less than 18% (see planting detail for more information.)

SETTING OF PLANTS. The root ball of container grown plants shall be scarified in several places prior to planting. Plant shrubs and trees so that after initial settlement, the top root balls will be even with or slightly above the adjacent soil line. Around root balls, 1/2 of the original soil shall be removed from the planting hole and throughly mixed with the same quantity peat moss or well rotted, fine textured bark. (Only in areas where the existing soil is 100% fertile, loose topsoil (brown or black in color) can plants be placed directly in the soil with no amendments). PLANTINGS NOT DONE IN THIS MANNER SHALL BE REMOVED AND PROPERLY REPLANTED.

PREPARATION OF GROUND COVER AND SEASONAL COLOR BEDS: The existing soil in ground cover and seasonal color beds shall be thoroughly cultivated 6 inches deep, to a fine texture (no clods over 1/2") with a mechanical tiller. A plant mix of 60% screened shredded topsoil, 20% sand, and 20% well rotted sawdust or peat shall then be thoroughly incorporated into the existing soil with the tiller so that the soil mix (6" deep) is 1/2 original soil and 1/2 plant mix. All groundcover and seasonal color beds shall receive a 2" layer of fine textured, screened, pine bark mulch, or equal. PLANTINGS NOT DONE IN THIS MANNER SHALL BE REMOVED AND PROPERLY REPLANTED.

FERTILIZING Upon completion of plantings, all shrubs shall receive 1/6 cup of 16-4-8 fertilizer (50% of nitrogen slow release) evenly broadcast at the base of the plants. Trees shall receive 1/4 cup of 16-4-8 fertilizer (50% of nitrogen slow release) per inch of caliper. Ground cover beds shall be fertilized at the rate of 20 pounds of 16-4-8 (50% of nitrogen slow release) per 1000 square feet.

STAKING OF TREES Deciduous trees, 1 1/2" in caliper and over, and evergreen trees, 8' and taller shall be staked. Rubberhose to be used to cover the wire at the point of its contact with the tree. The Landscape Contractor is responsible for all wind damage to trees, (provided winds are less than 60mph) during the guarantee period, and may stake other trees (for his own protection) at his option. TRANSPLANTS All plant material to be transplanted shall be transplanted according to guidelines set by AAN standards. Transplanted material will not be guaranteed by the landscape contractor.

MULCHING As specified on planting list. Hardwood mulch: All beds to receive a 3" layer of aged hardwood bark mulch (free of wood chips or large chunks of bark). Fresh hardwood bark mulch is not recommended to be used, as water run-off may cause staining on adjacent concrete surfaces. All damages incurred by the use of fresh hardwood mulch shall be the responsibility of the landscape contractor. Pinestraw: All beds to receive a 4" layer (prior to compaction) of pinestraw. After natural compaction, pinestraw should have a depth of 2". All trees located in lawn areas shall receive a 3' diameter ring of mulch. Mulch in these areas is to follow the above listed guidelines. A weed barrier shall be provided in all bed areas under mulch layer.

GRADING All final grading shall be the responsibility of the landscape contractor. The responsibility for any additional grading (if needed) shall be determined prior to bidding.

BACKFILL Landscape contractor to verify any additional backfill/topsoil needed prior to beginning work. A unit price for topsoil shall be included in all bid documents to allow for circumstances that might arise during installation.

STABILIZATION Landscape contractor shall ensure that all plantings are stabilized with ground covers, mulches or other approved materials to prevent soil erosion and allow rainwater infiltration.

CLEAN UP Final clean up of any disturbances occurring as a result of landscape operations shall be the responsibility of the landscape contractor.

INSPECTION It shall be the contractor's responsibility to provide for inspection of the plant material by the Landscape Architect prior to installation. All plant material will be inspected. Plants not conforming precisely to the plant list will not be accepted and shall be replaced at the contractor's own

LICENSES The contractor will be responsible for obtaining all licenses necessary to complete the work.


INSURANCE With the submittal of bid documents, the landscape contractor shall also submit a certificate of insurance for workman's compensation and a contractor's general liability. Contractors not providing evidence of such insurance will be ineligible to recieve the contract for the job


GUARANTEE All plant material and workmanship to be guaranteed for one year from the date of acceptance by the Owner. Plant replacement to occur only once. The contractor will not be responsible for defects resulting from neglect by the Owner, abuse or damage by others, or unusual phenomena or incidents beyond the landscape contractors control which result from natural causes such as floods, lightning, storms, freezing rains, or winds over 60

IRRIGATION All planting beds shall be drip irrigated, all sod areas shall be spray irrigated, any other disturbed areas shall be seeded. An automatic

PLANT SCHEDULE

TREES	CODE	BOTANICAL NAME	COMMON NAME	SIZE		<u>QTY</u>	REMARKS
Andrew Color	CEBR	Cedrus deodara `Bracken`s Best Cedar`	Bracken`s Best Deodar Cedar	3" Cal.		4	
	QUPA	Quercus palustris	Pin Oak	3" Cal. 14` Ht.		9	6` Clear Trunk
	QURU	Quercus rubra	Red Oak	3" Cal. 14` Ht.		6	6` Clear Trunk
	ULAL	Ulmus parvifolia `Allee`	Allee Lacebark Elm	3" Cal. 14` Ht.		6	6` ClearTrunk
1`-4` EVERGREEN SHRUB	CODE	BOTANICAL NAME	COMMON NAME	SIZE		QTY	REMARKS
\bigcirc	AGKA	Abelia x grandiflora `Kaleidoscope`	Glossy Abelia	3 gal		66	18" Ht. Min.
\bigcirc	ICCA	Ilex cornuta `Carissa`	Carissa Holly	3 gal		37	18" Ht. Min.
6`+ EVERGREEN SHRUB	CODE	BOTANICAL NAME	COMMON NAME	SIZE		<u>QTY</u>	REMARKS
	LIRE	Ligustrum japonicum `Recurvifolium`	Wax leaf ligustrum	4` Ht.		17	
ORNAMENTAL TREE	CODE	BOTANICAL NAME	COMMON NAME	SIZE		<u>QTY</u>	REMARKS
	LAIN	Lagerstroemia indica	Crape Myrtle	2" Cal. 3 Canes Min.		15	10` Ht Min. 5` Clear Trunk
SMALL EVERGREEN TREE	CODE	BOTANICAL NAME	COMMON NAME	SIZE		<u>QTY</u>	REMARKS
{ · · · · · · · · · · · · · · · · · · ·	MGLG	Magnolia grandiflora `Little Gem`	Dwarf Southern Magnolia	6` Ht		6	
GROUND COVERS	CODE	BOTANICAL NAME	COMMON NAME	SIZE	SPACING	QTY	REMARKS
	LIBI	Liriope muscari `Big Blue`	Big Blue Lilyturf	1 gal.	24" o.c.	269	

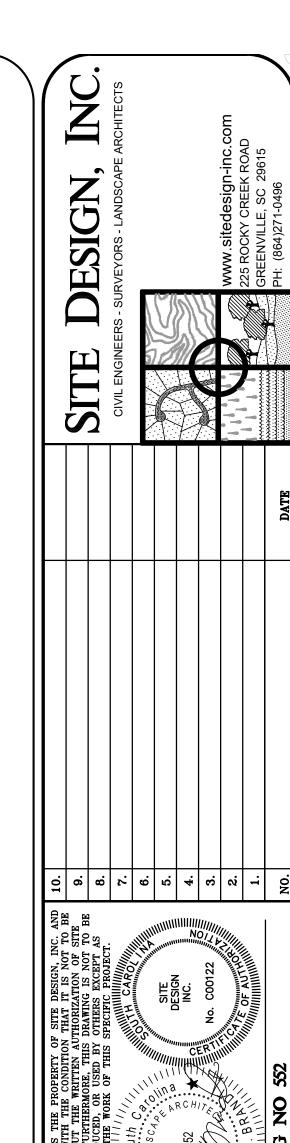

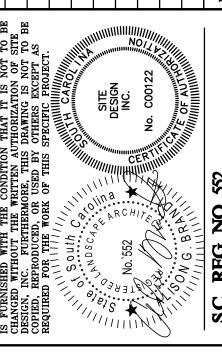

THE PARK AT **HANAHAN**

CITY OF HANAHAN BERKELEY COUNTY SOUTH CAROLINA

THE PARK AT HANAHAN, LP 3715 NORTHSIDE PKWY, NW **BLDG 400, SUITE 120** ATLANTA, GA 30327

HORZ. SCALE: N/A N/A VERT. SCALE: DESIGNED BY. JAW JAW DRAWN BY. AGB CHECKED BY: 1/8/2021 S200437-LANDSCAPE.dwg

> LANDSCAPE **DETAILS**

SHEET140F14



